







BACONG PILIPIN

DEPARTMENT OF TRANSPORTATION
CIVIL AVIATION AUTHORITY OF THE PHILIPP

THIS DRAWING AND DESIGN IS EXCLUSIVE PROPERTIES OF CIVIL AVIATION AUTHORITY OF THE PHILIPPINES AND SUCH MUST NOT BE REPRODUCED. EXHIBITED, LOANED NOR COPIED IN PART OR IN WHOLE WITHOUT PROPER PERMISSION AND/OR WRITTEN CONSENT FROM THE DIRECTOR GENERAL

AERODROME DEVELOPMENT AND MANAGEMENT SERVICE

INFRASTRUCTURE DEVELOPMENT AND DESIGN

		CHERON CHEROSCO
	DESIGN STAFF:	INITIAL / DATE
	DESIGNED BY:	IDDD
*	DRAWN BY:	IDDD 1212
100	REVIEWED BY:	-
22		

CHECKED



SUBMITTED BY:



RECOMMEND APPROVAL:



APPROVED:

CAPTAIN MANUELANTONIOL TAMA

NOTES/REVISIO

IMPROVEMENT/REHABILITATION OF PASSENGER TERMINAL BUILDING OF ITBAYAT AIRPORT

LOCATION:

ITBAYAT, BATANES

SHEET CONTENT

LOCATION MAP VICINITY MAP PLAN ON SITE PERSPECTIVE

A-1
















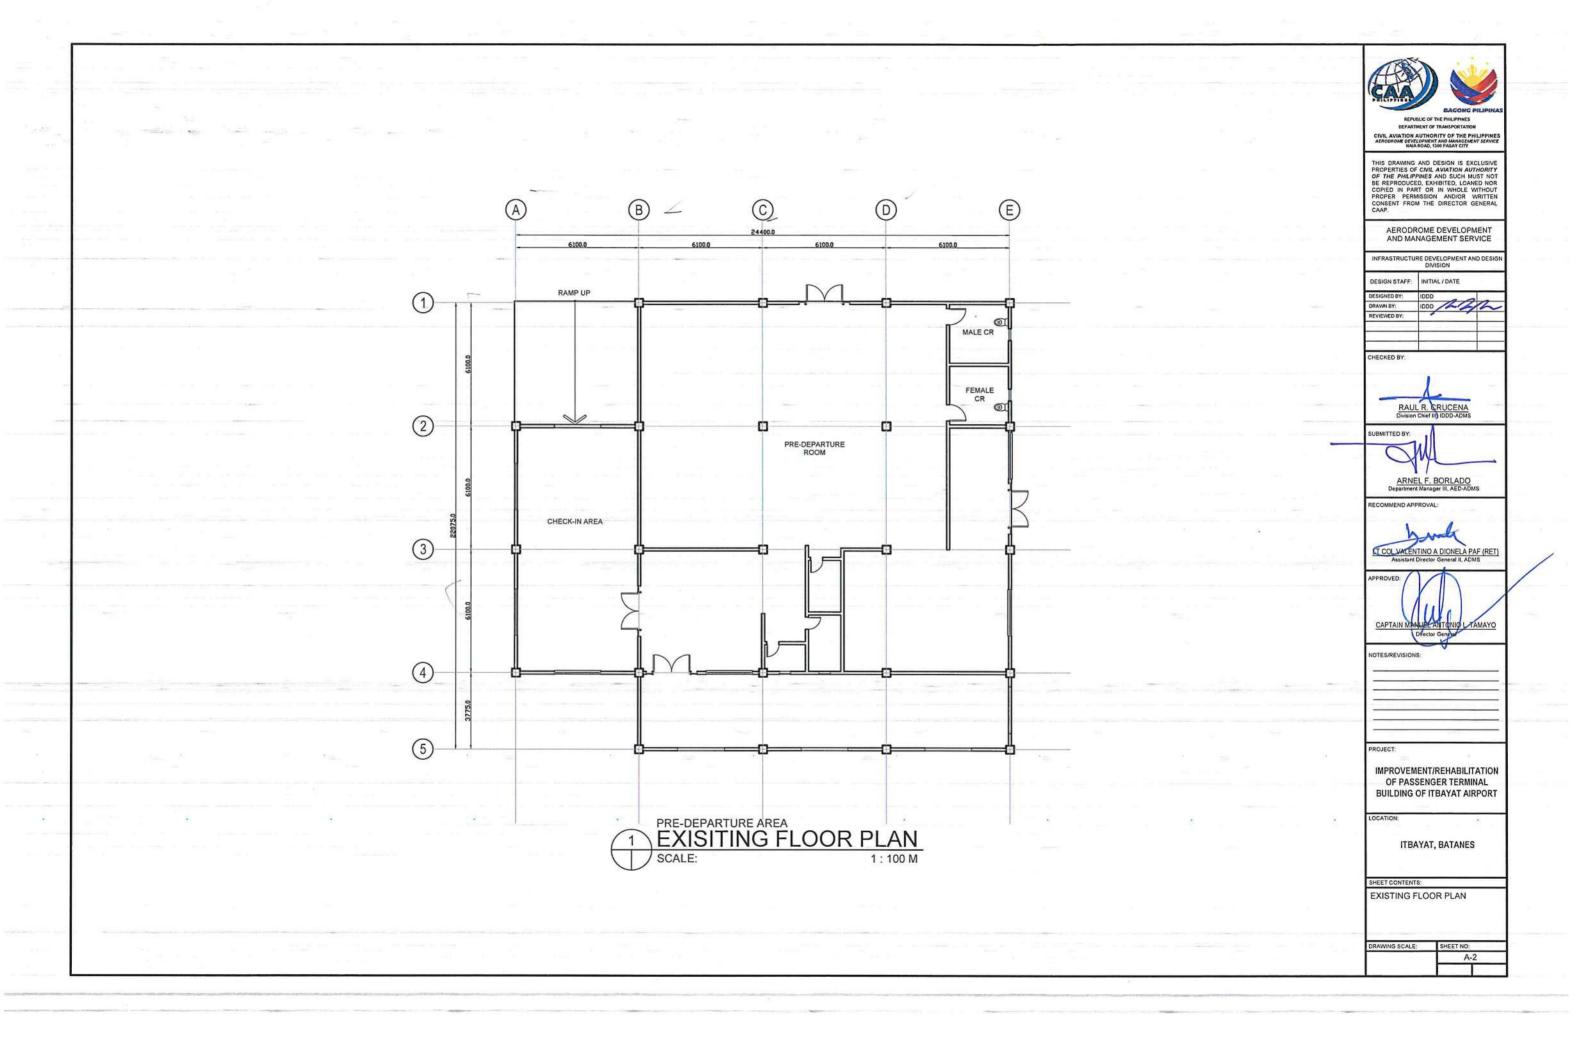


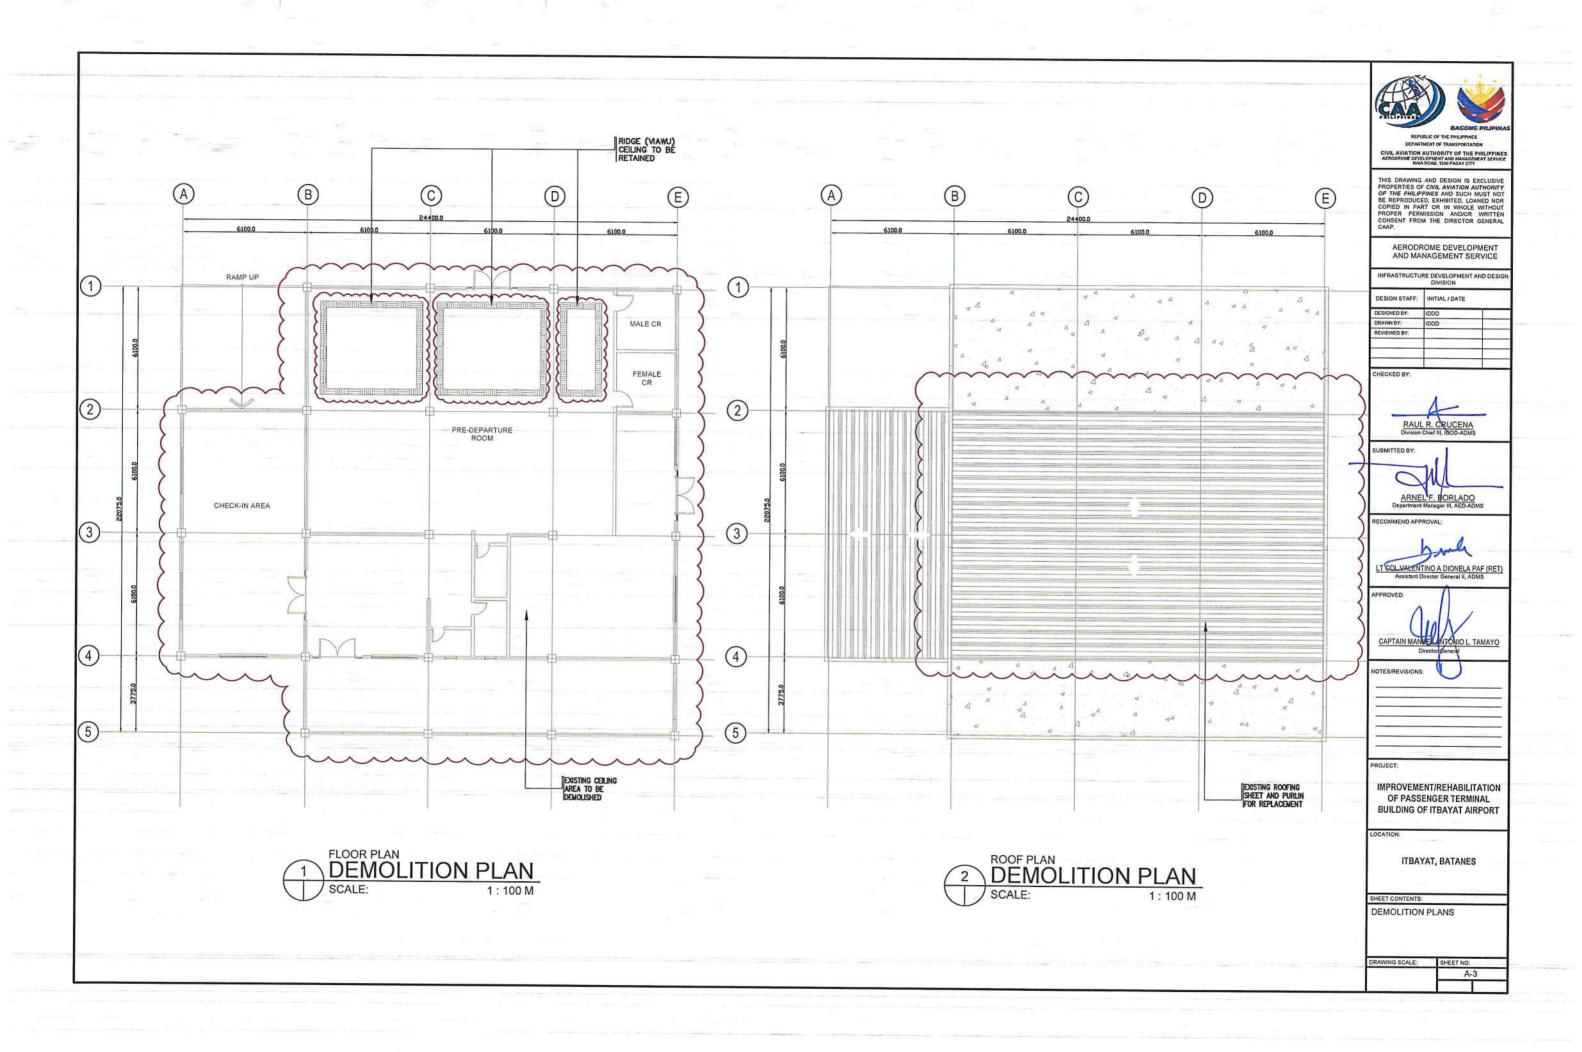

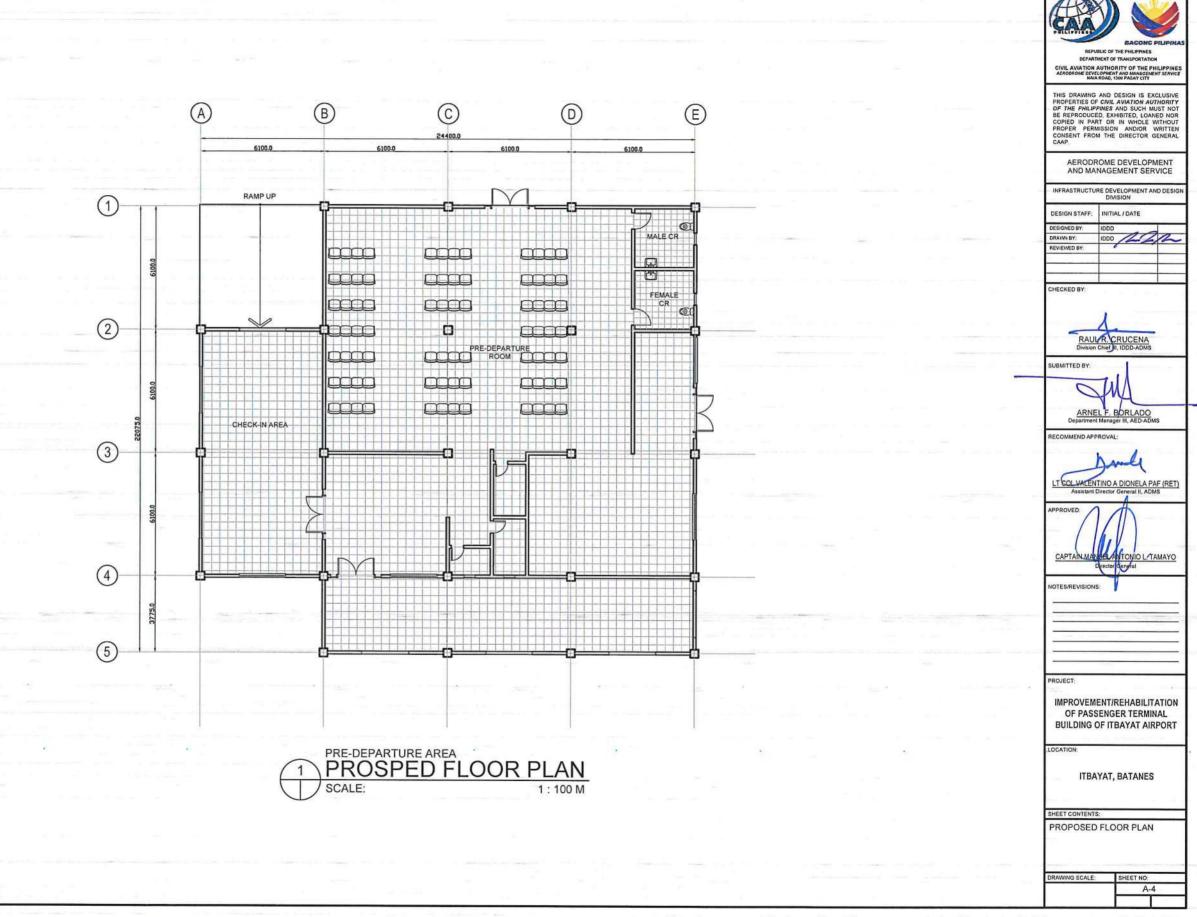

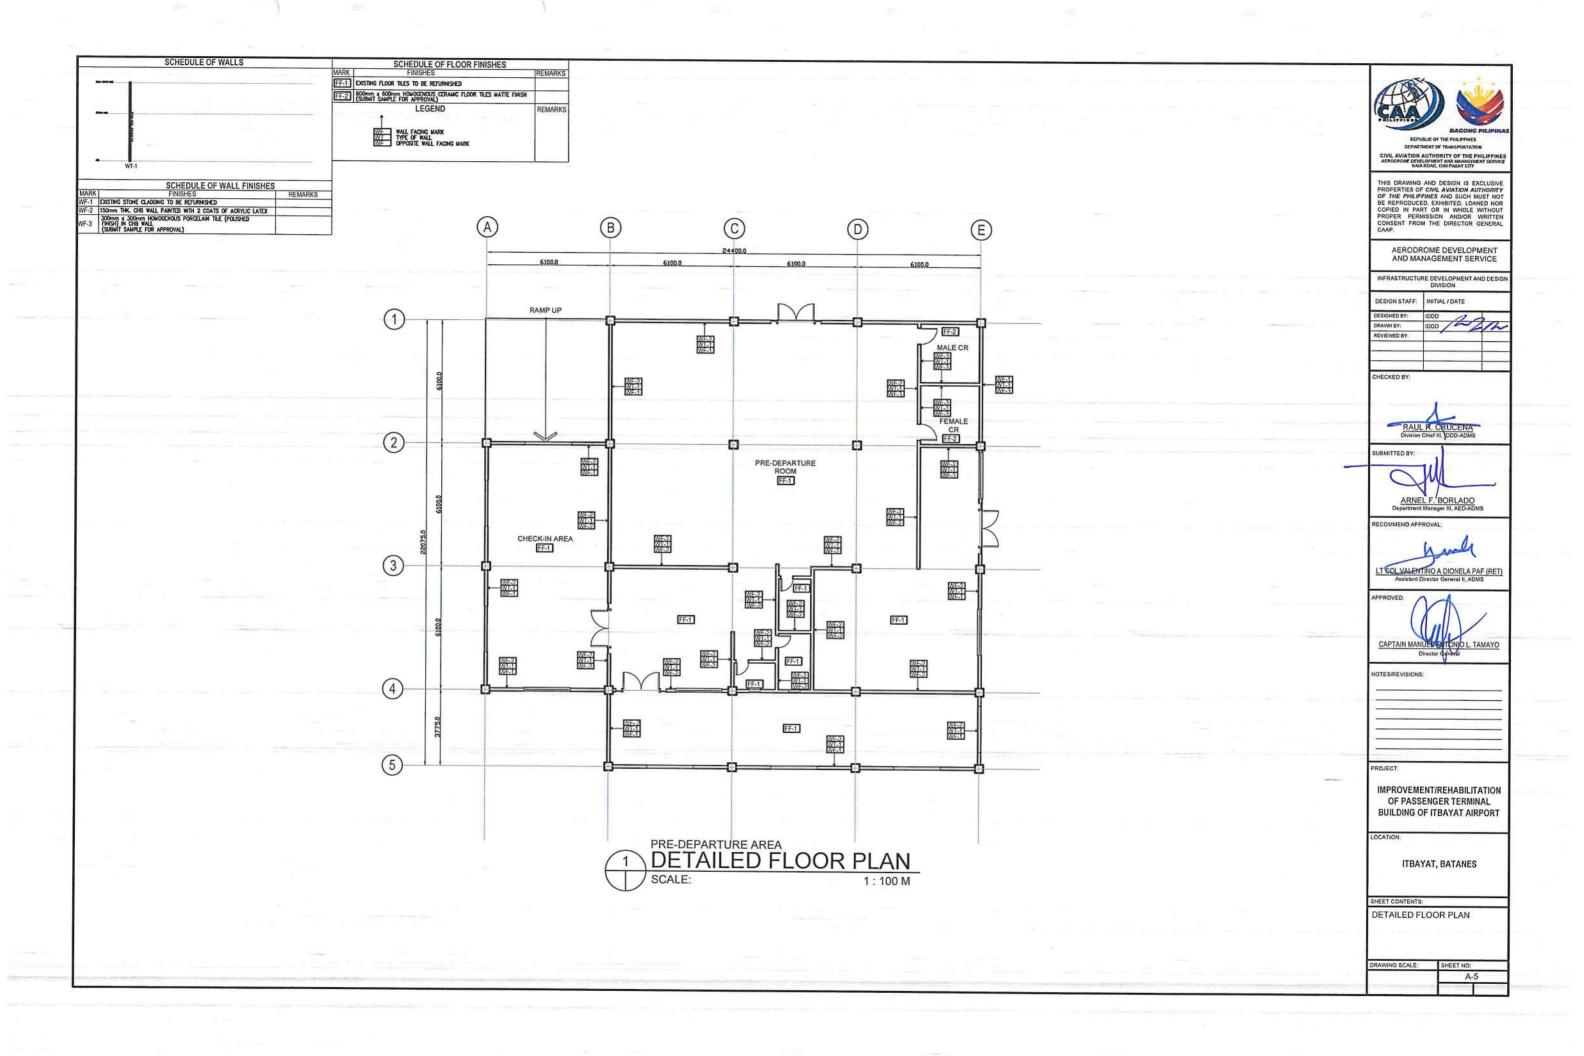

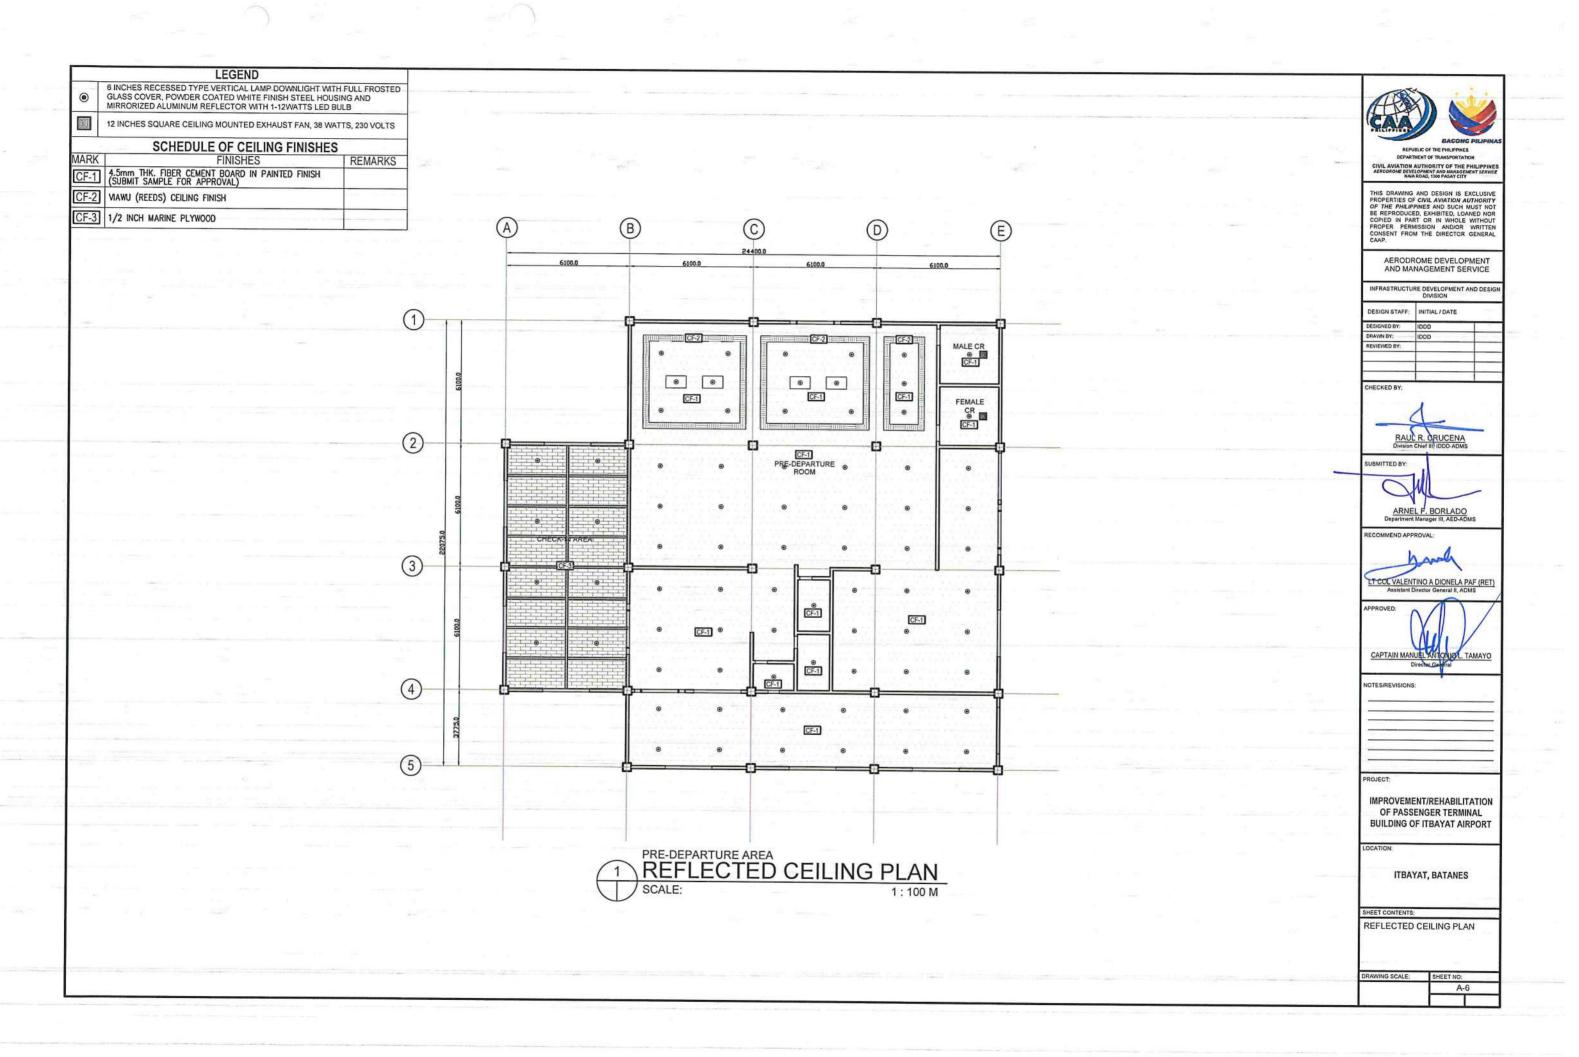

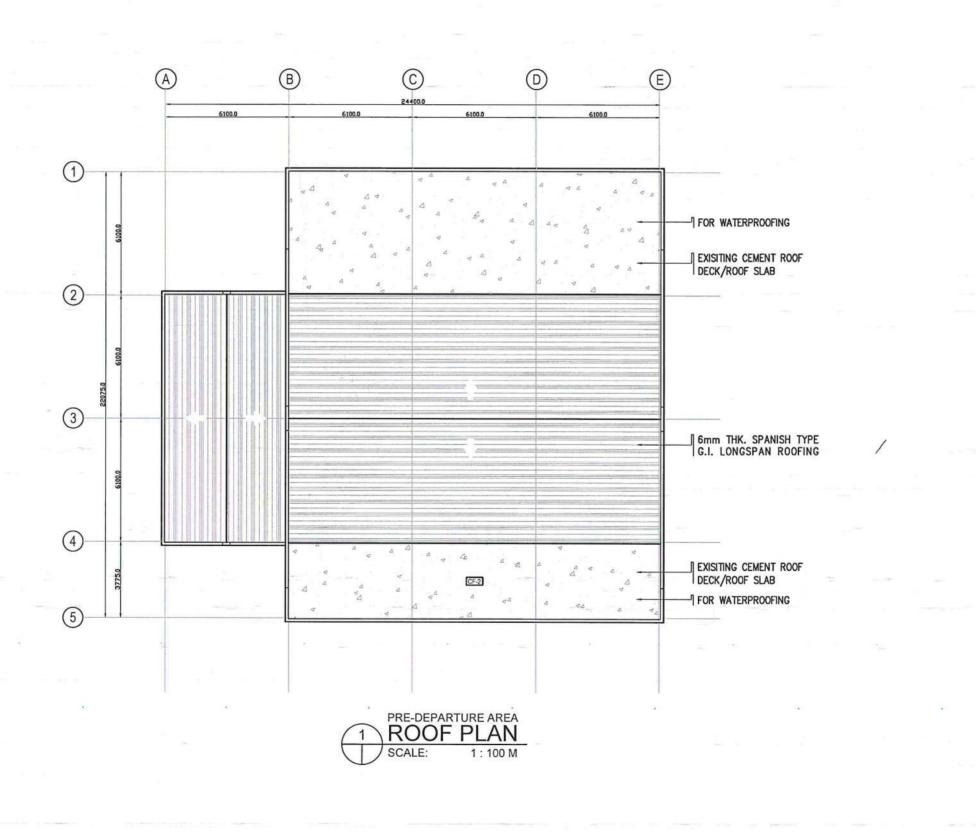





REPUBLIC OF THE PHILIPPINES
DEPARTMENT OF TRANSPORTATION
CIVIL AVIATION AUTHORITY OF THE PHILIPPIN
AERODROME DEVELOPMENT AND MANAGEMENT SERVI

THIS DRAWING AND DESIGN IS EXCLUSIVE PROPERTIES OF CIVIL AWATION AUTHORY OF THE PHILIPPINES AND SUCH MUST NO BE REPRODUCED, EXHIBITED, LOANED OCICIPIED IN PART OR IN WHOLE WITHOUT PROPER PERMISSION AND/OR WRITTE CONSENT FROM THE DIRECTOR GENERAL CAAP.

AERODROME DEVELOPMENT AND MANAGEMENT SERVICE

INFRASTRUCTURE DEVELOPMENT AND DESIGN

DESIGN STAFF:	INITIAL / DATE
DESIGNED BY:	IDDD
DRAWN BY:	IDDD /LJA
REVIEWED BY:	

CHECKED BY:



SUBMITTED BY:

ARNEL F. BORLADO

RECOMMEND APPROVAL:

LT COLVALENTINO A DIONELA PAF (RET)
Assistant Director, General II, ADMS

4h)

NOTES/REVISIONS

-	-


IMPROVEMENT/REHABILITATION OF PASSENGER TERMINAL BUILDING OF ITBAYAT AIRPORT


LOCATIO

ITBAYAT, BATANES


ROOF PLAN

DRAWING SCALE: SHEET NO:
A-7

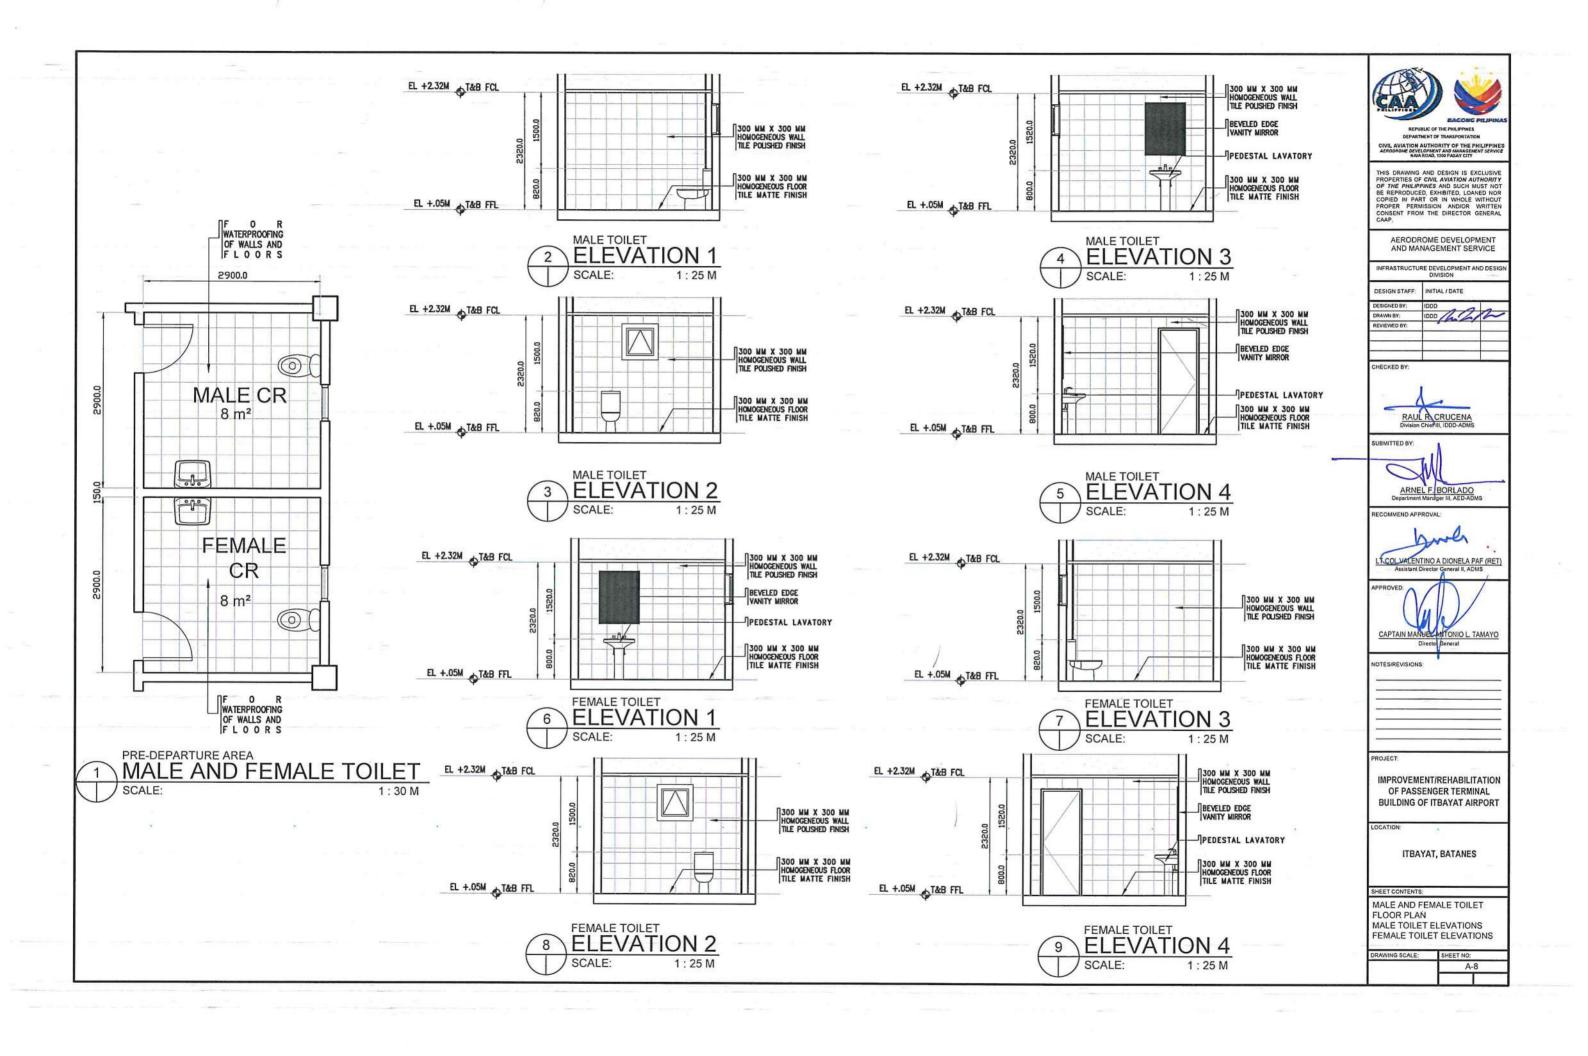

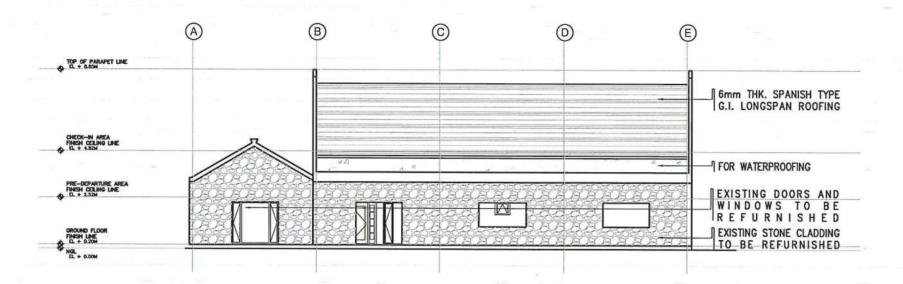



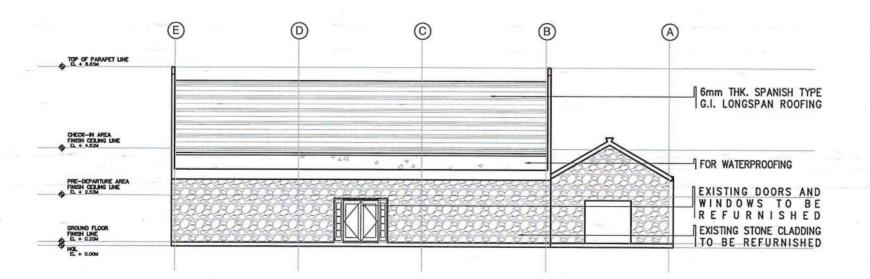







DEPARTMENT OF TRANSPORTATION

CIVIL AVIATION AUTHORITY OF THE PHILIPPIN
AERODROME DEVELOPMENT AND MANAGEMENT SERV

THIS DRAWING AND DESIGN IS EXCLUSIVE PROPERTIES OF CIVIL AVIATION AUTHORITY OF THE PHILIPPINES AND SUCH MUST NOT BE REFRODUCED, EXHIBITED, LOANED NON COPIED IN PART OR IN WHOLE WITHOUT PROPER PERMISSION AND/OR WRITTEN CONSENT FROM THE DIRECTOR GENERAL CAAP.

AERODROME DEVELOPMENT AND MANAGEMENT SERVICE

INFRASTRUCTURE DEVELOPMENT AND DESIG

DESIGNED BY:	IDDD
DRAWN BY:	IDDD /
REVIEWED BY:	

CHECKED BY:



SUBMITTED BY:

ARNEL F. BORLADO

RECOMMEND APPROVA

LT COL VALENTINO A DIONELA PAF (RET)
Assistant Director General II, ADMS

APPROVE

CAPTAIN MANUEL ANTONIO L. TAMAYO
Director General

NOTES/REVISIONS

IMPROVEMENT/REHABILITATION OF PASSENGER TERMINAL BUILDING OF ITBAYAT AIRPORT


LOCATIO

ITBAYAT, BATANES


SHEET CONTENTS:

FRONT ELEVATION REAR ELEAVTION

DRAWING SCALE: SHEET NO:
A-9

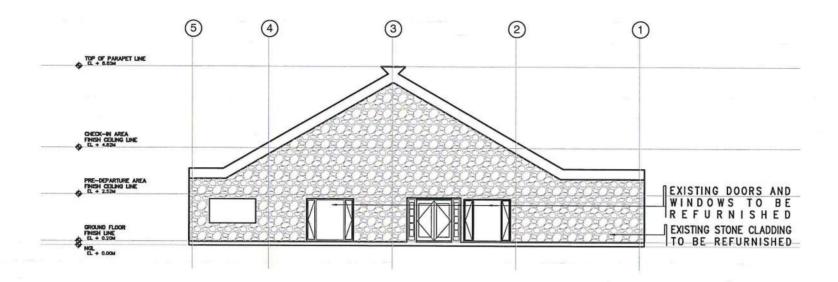



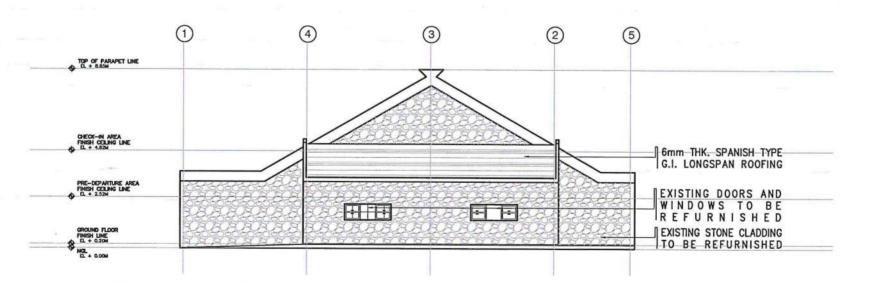







REPUBLIC OF THE PHILIPPINES DEPARTMENT OF TRANSPORTATION

THIS DRAWING AND DESIGN IS EXCLUSIVE PROPERTIES OF CIVIL AVIATION AUTHORITY OF THE PHILIPPINES AND SUCH MUST NOT BE REPRODUCED, EXHIBITED, LOANED NOR COPIED IN PART OR IN WHOLE WITHOUT PROPER PERMISSION ANDIOR WRITTEN CONSENT FROM THE DIRECTOR GENERAL CAAP.

AERODROME DEVELOPMENT AND MANAGEMENT SERVICE

INFRASTRUCTURE DEVELOPMENT AND DESIGN

DESIGNED BY:	IDDD
DRAWN BY:	IDDD
REVIEWED BY:	

CHECKED



SUBMITTED BY:

ARNEL F. BORLADO

RECOMMEND APPROVA

LT COL VALENTINO A DIONELA PAF (RET)
Assistant Director General II, ADMS

APTAIN MANUEL ANTONIO L. TAMA

NOTES/REVISION:

IMPROVEMENT/REHABILITATION OF PASSENGER TERMINAL BUILDING OF ITBAYAT AIRPORT


LOCATIO


ITBAYAT, BATANES


SHEET CONTENTS:


RIGHT SIDE ELEVATION LEFT SIDE ELEVATION


DRAWING SCALE: SHEET NO:
A-10

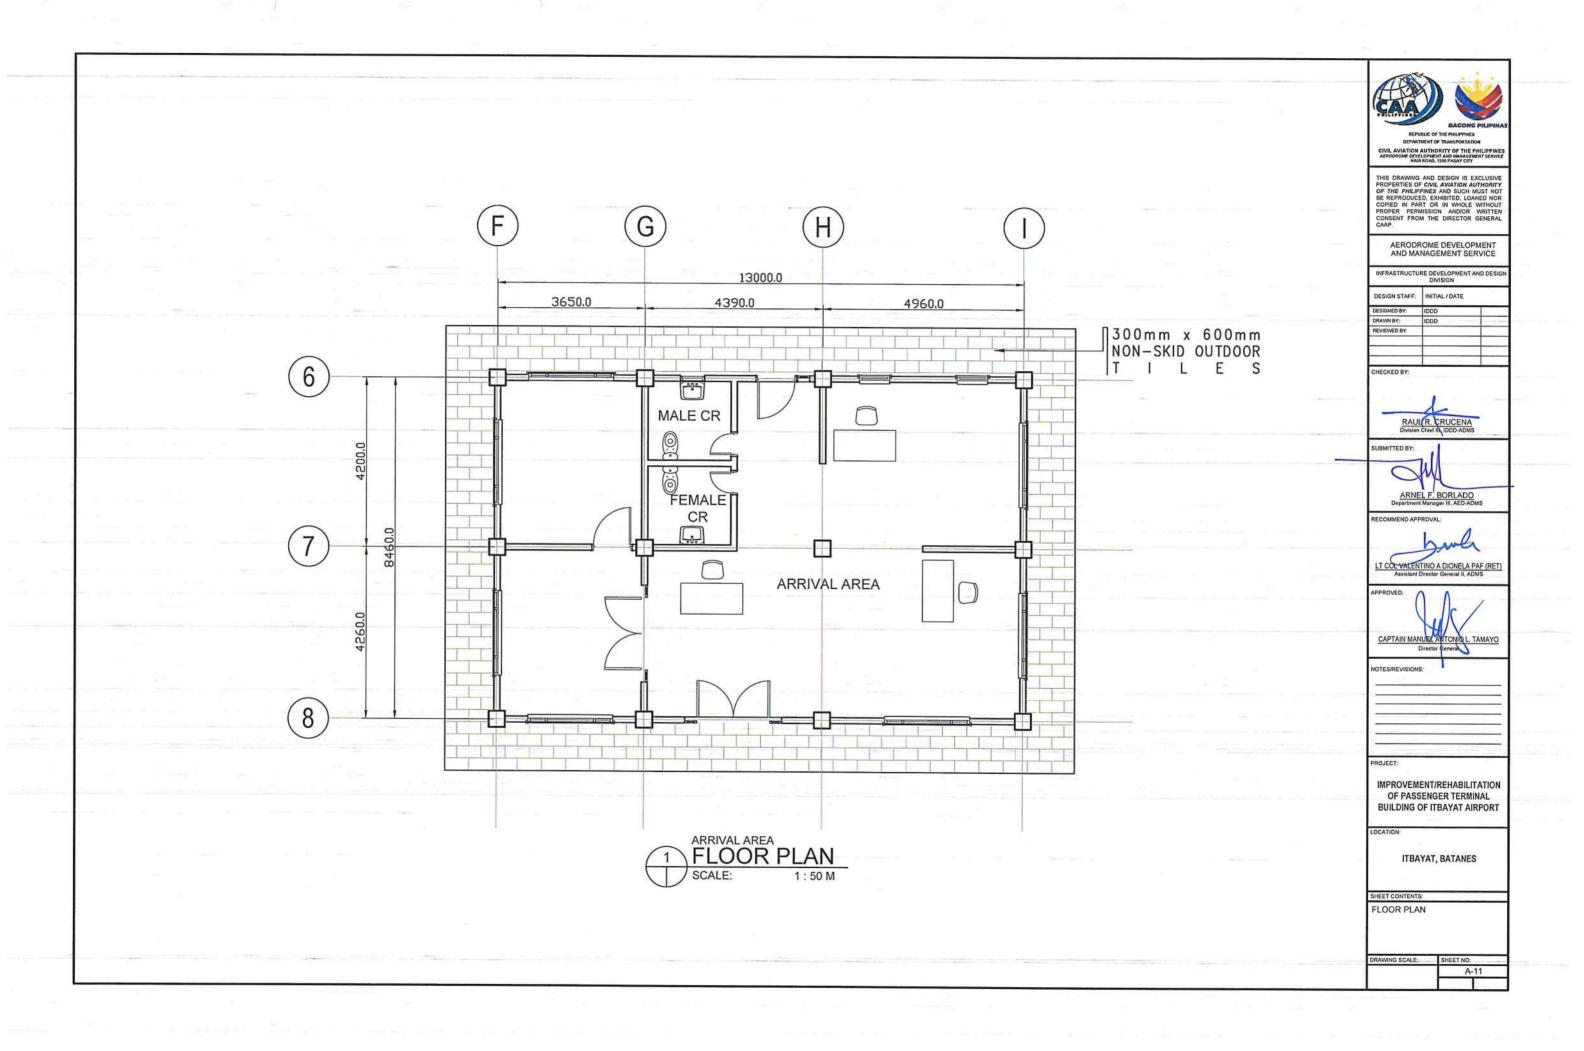


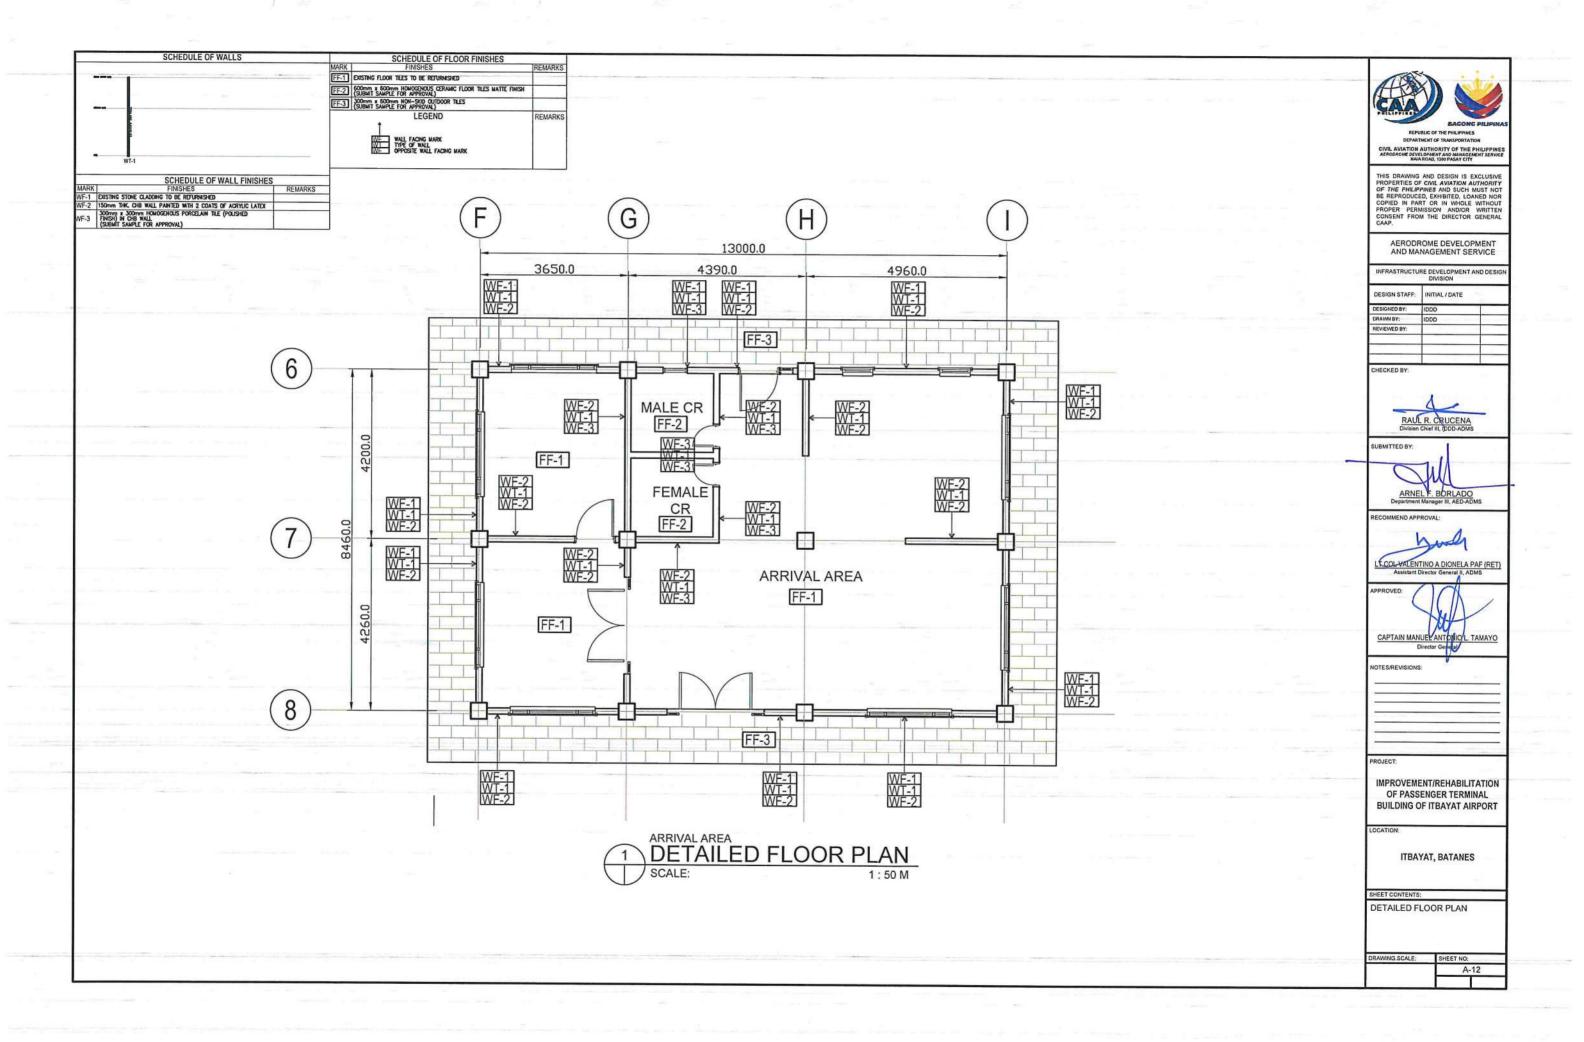

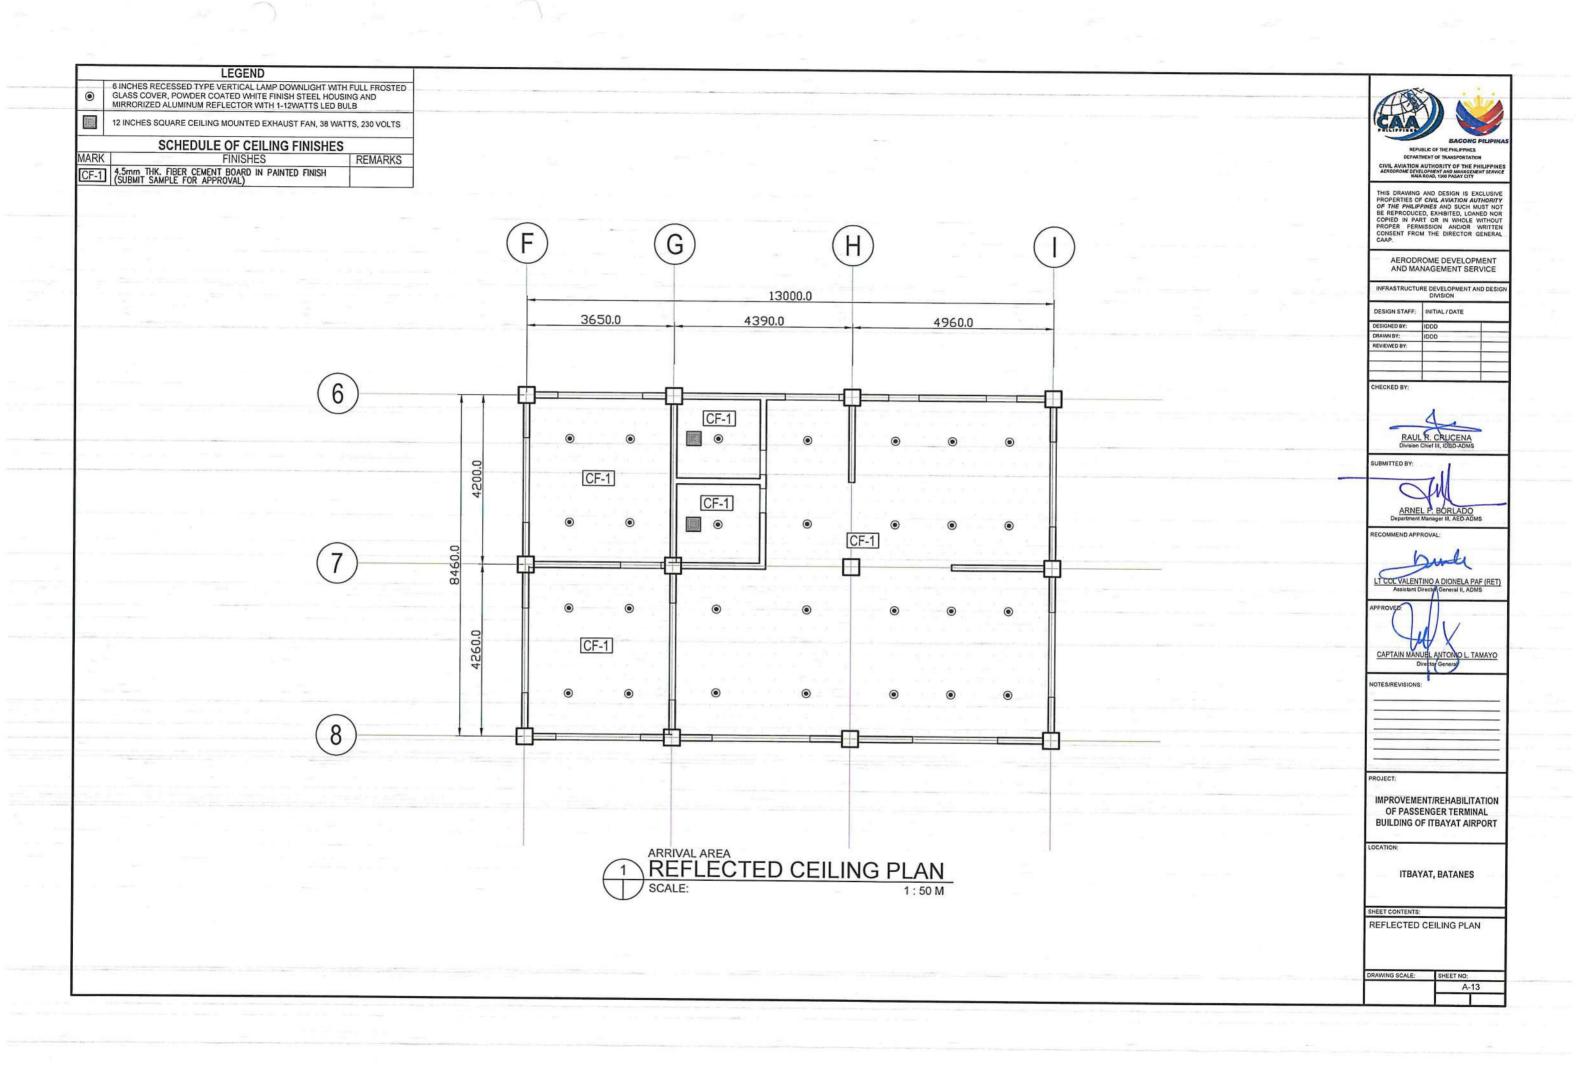

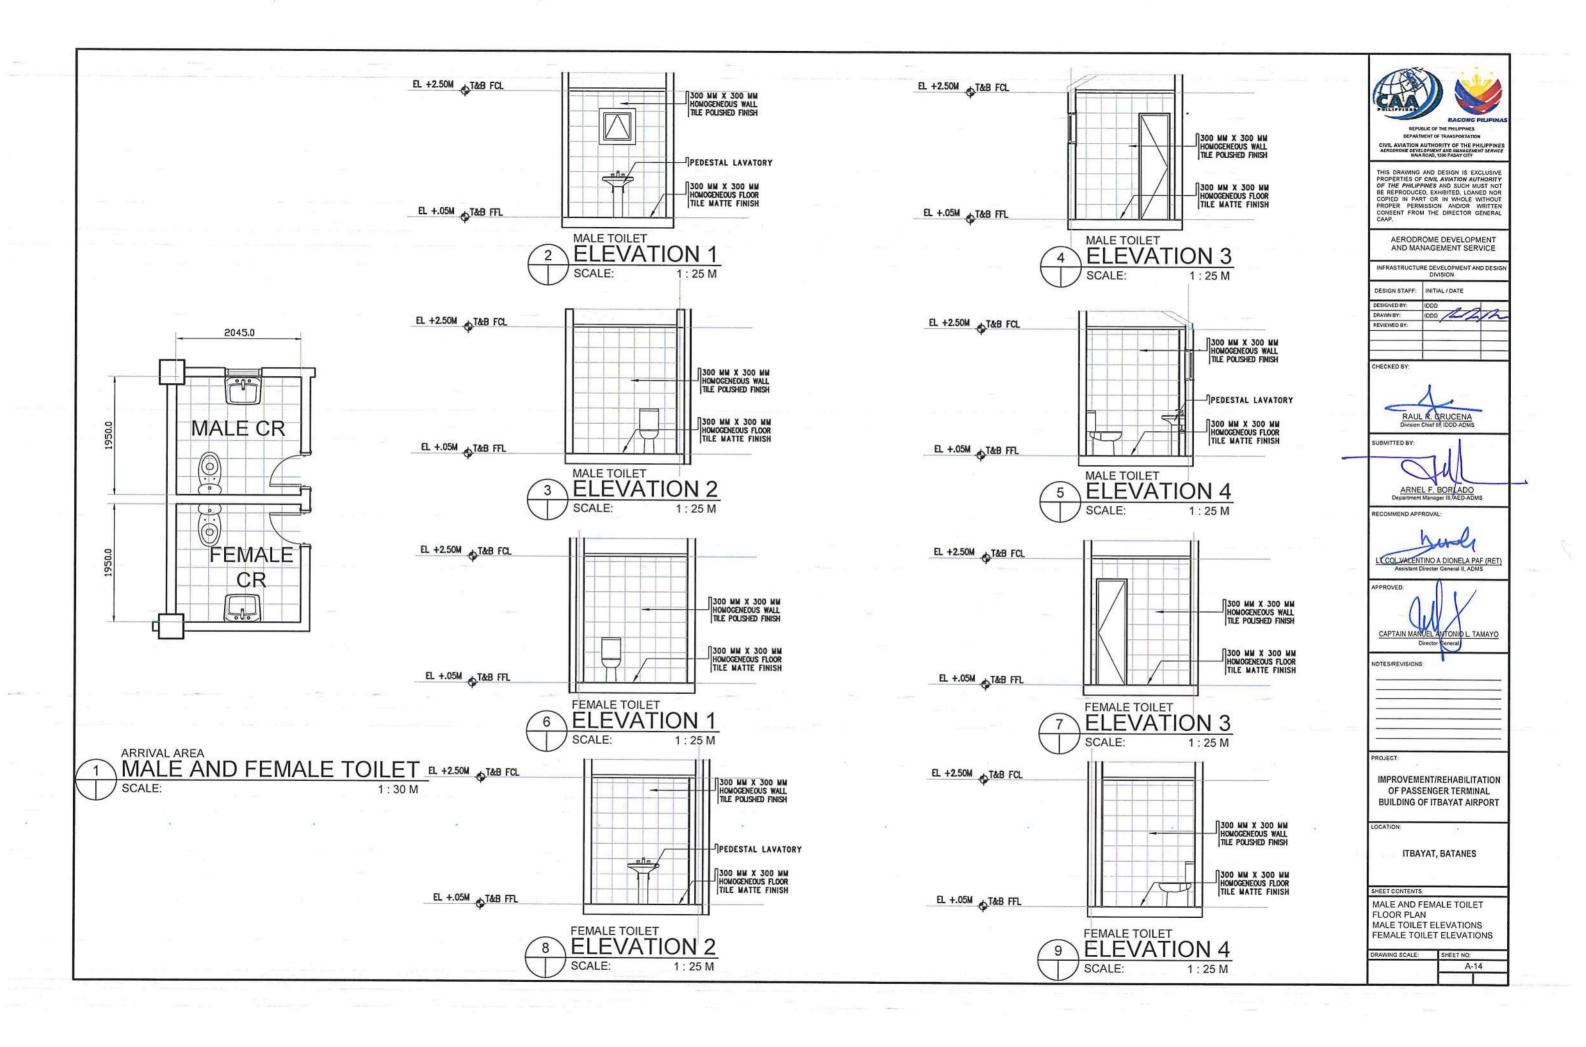


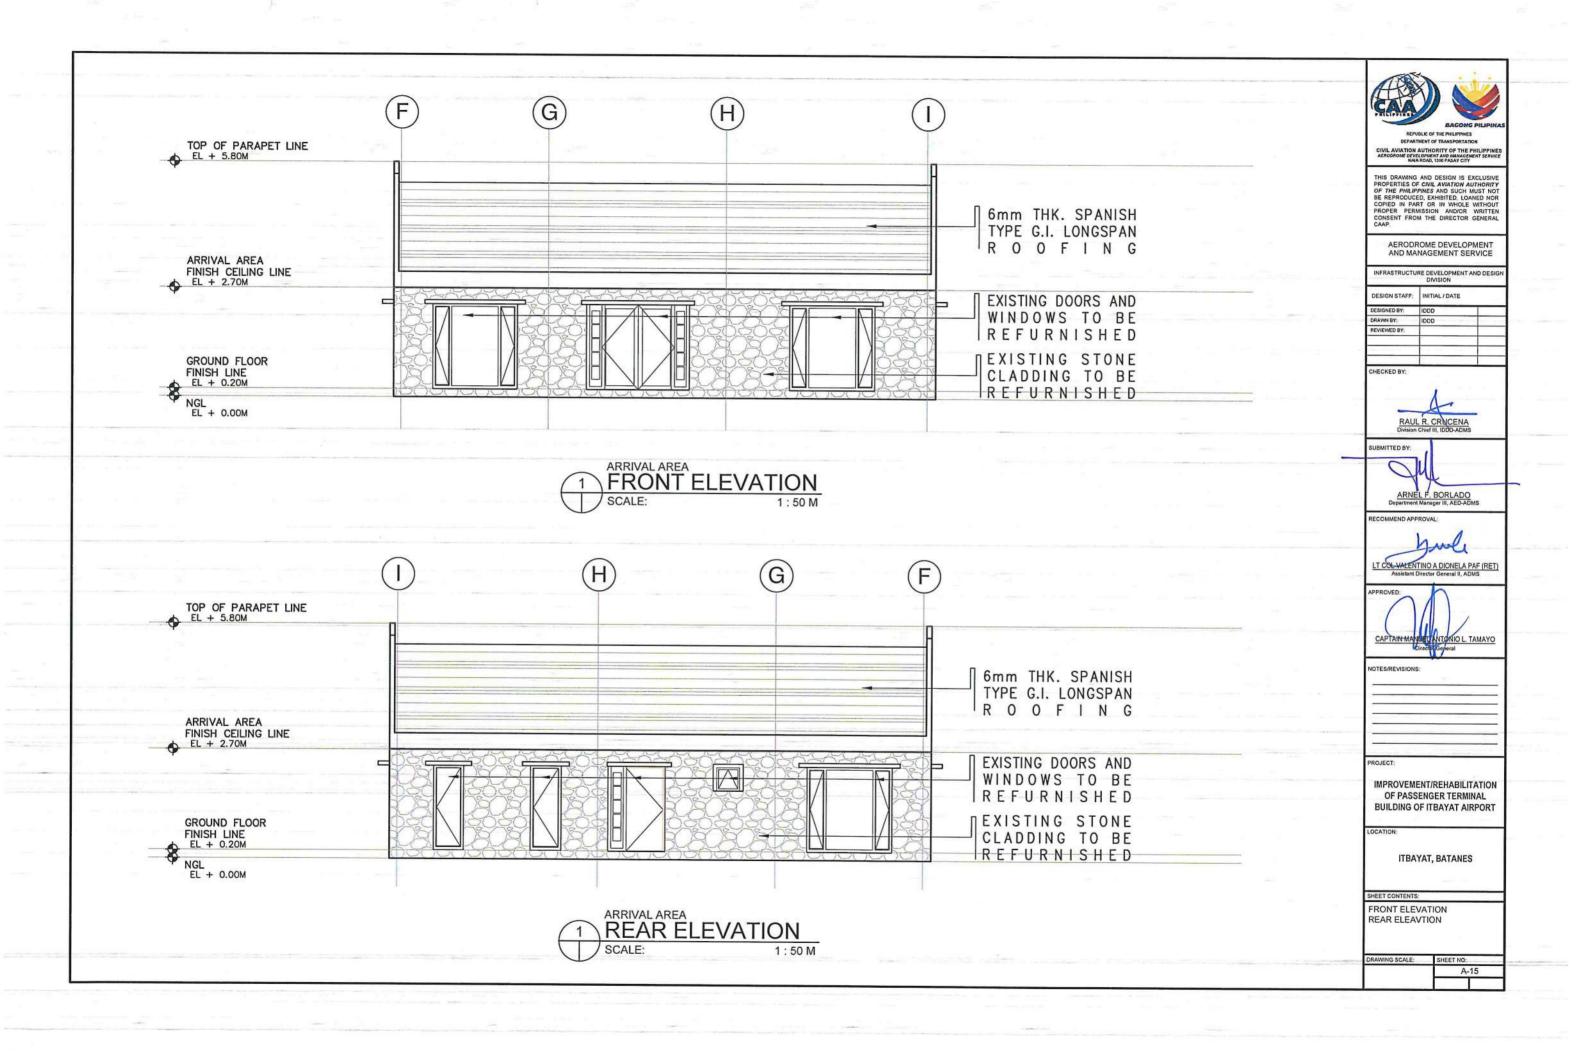

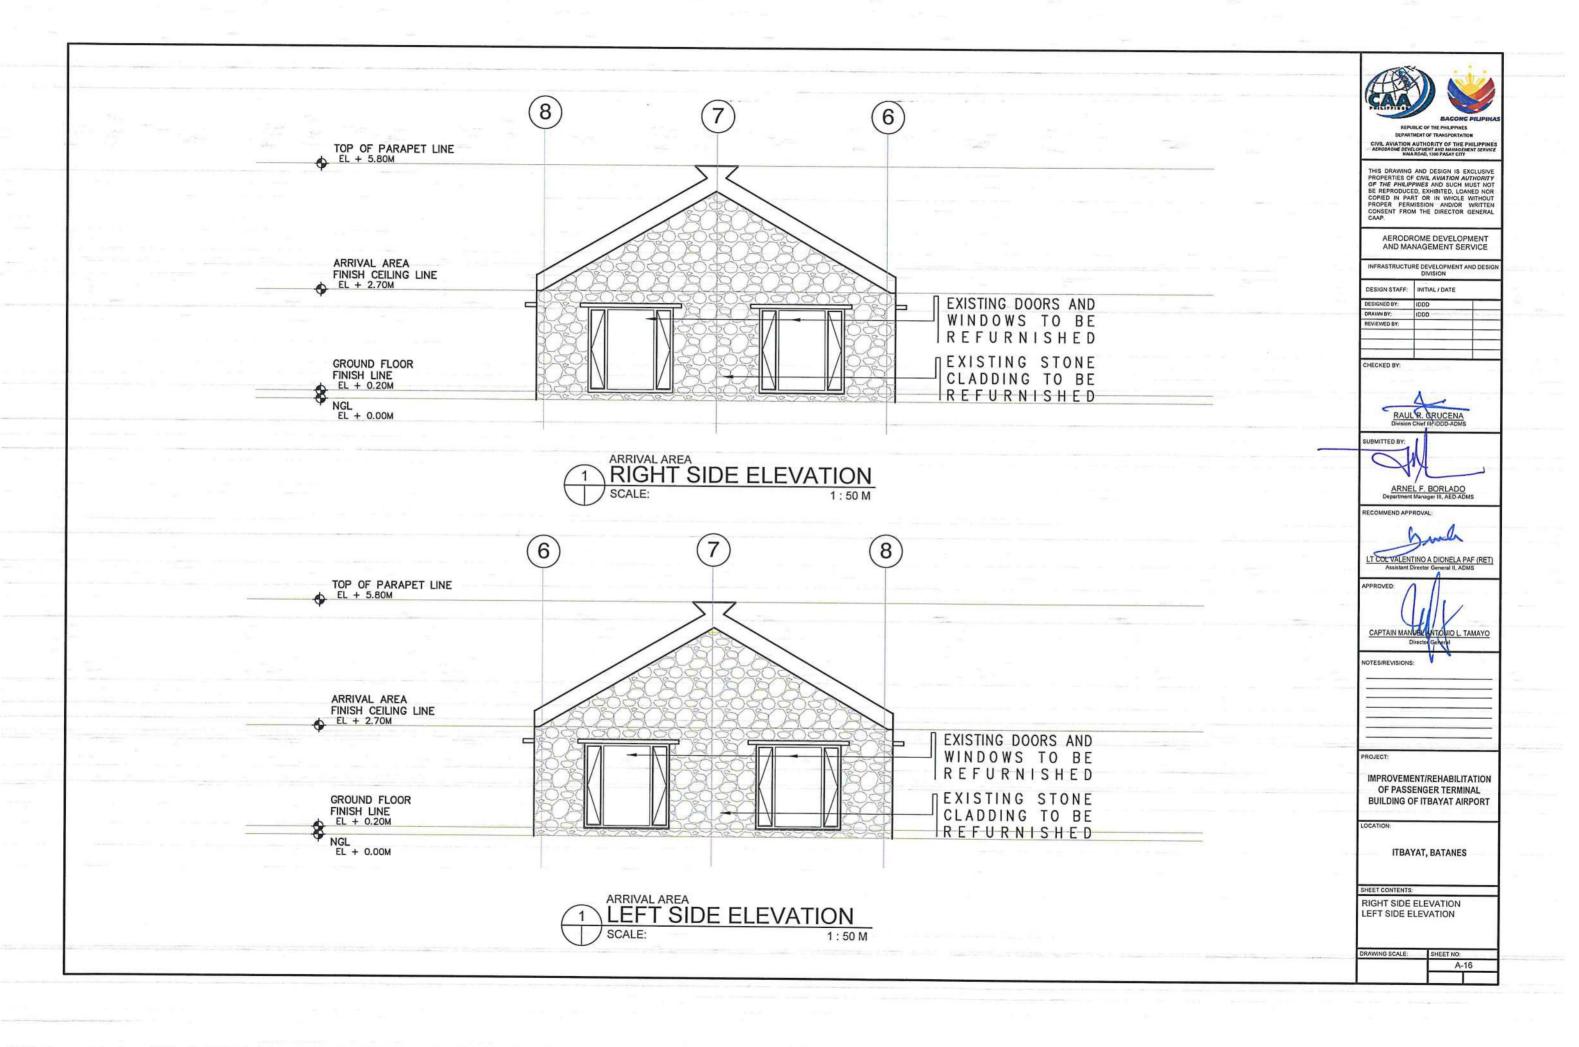

GENERAL NOTES & SPECIFICATIONS:


- ALL ELECTRICAL WORKS AND INSTALLATIONS SHALL COMPLY WITH THE PROVISIONS OF THE LATEST EDITION OF THE PHILIPPINE ELECTRICAL CODE WITH THE RULES AND REGULATIONS OF THE NATIONAL AND LOCAL AUTHORITIES CONCERNED IN THE ENFORCEMENT OF ELECTRICAL LAWS AND REGULATIONS OF THE UTILITY COMPANIES CONCERNED.
- 2. ALL ELECTRICAL WORKS HEREIN SHALL BE DONE UNDER THE DIRECT SUPERVISION OF A DULY LICENSED ELECTRICAL ENGINEER...
- GENERAL USED RECEPTACLE SHALL BE RATED 16 AMPERES, 2 POLE, 250 VOLTS, UNIVERSAL TYPE WITH GROUND WITH PARALLEL SLOTS, SPECIAL PURPOSE OUTLET SHALL BE OF THE TYPE AND RATING INSULATED FOR RATING SUITED FOR THE EQUIPMENT SERVED.
- 4. ALL ELECTRICAL EQUIPMENT SHALL BE PROPERLY GROUNDED IN ACCORDANCE WITH THE REQUIREMENT OF THE PHILIPPINE ELECTRICAL CODE.
- 5. ALL MATERIALS TO BE USED SHALL BE BRANDED AND SHALL BE NEW AND OF THE APPROVED TYPE FOR BOTH LOCATION AND PURPOSE INTENDED.
- 6. ELECTRICAL PIPES, WIRES AND CABLES TO BE USED SHALL BE UNDERWRITERS LABORATORY (UL) LISTED.
- 7. EMERGENCY LAMPS SHALL BE CONNECTED TO THE NEAREST LIGHTING CIRCUIT AND PROVIDE SIMPLEX CONVENIENCE OUTLET.
- 8. MANHOLES, HAND HOLES, JUNCTION BOXES, PULL BOXES, AND WIRE GUTTER GAUGE NO. 16 (MINIMUM) SHALL BE PROVIDED BY THE CONTRACTOR WHENEVER REQUIRED AND NECESSARY AND SHALL BE INSTALLED AT CONVENIENT SPACE AND LOCATION TO FACILITATE WIRE PULLING EVEN IF THESE ITEMS ARE NOT SHOWN IN THE PLAN.
- 9. ROUTING OF FEEDERS AND BRANCH CIRCUITS SHALL BE DONE IN THE FIELD WITH THE APPROVAL OF THE SUPERVISING REPRESENTATIVE OF CAAP.
- 12. PROVIDE SUFFICIENT MICA TUBE AND FLEXIBLE METAL CONDUIT FROM JUNCTION BOX TO TO LIGHTING FIXTURE.
- 13. PANEL BOARD SHALL BE EQUIPPED WITH GROUND KIT TERMINALS WITH NUMBER OF TERMINALS EQUAL TO THE NUMBER OF BRANCH CIRCUITS.
- 14. PRINTED INDEX LABEL SHALL BE AFFIXED TO INSIDE SURFACE OF EACH PANEL BOARD DOOR, CLEARLY INDICATING AREA AND TYPE OF LOAD SERVED BY EACH BRANCH CIRCUIT PROTECTIVE DEVICE, INCLUDING SPARES, HAND WRITTEN WILL NOT BE ACCEPTED. ENGRAVED LAMINATED PLASTIC IDENTIFICATION PLATES SHALL BE FURNISHED AND INSTALLED ON ALL PANELS, PANELS SHALL BE AFFIXED IN FRONT OF PANELS.
- 15. LOAD DATA IS BASED ON INFORMATION GIVEN TO THE ENGINEER AT THE TIME OF DESIGN. VERIFY ALL EQUIPMENT NAMEPLATE RATING BEFORE ORDERING.
- 16. ALL BRANCH CIRCUIT BREAKER SHALL BE BOLT-ON TYPE WITH 10 KAIC MINIMUM OR AS INDICATED IN THE LOAD SCHEDULE.
- 17. FOR EACH SPARE BRANCH CIRCUIT IN PANELBOARD, PROVIDE ONE 20MMØ EMPTY CONDUIT CONNECTED TO AN OCTAGONAL BOX AT ABOVE CEILING.
- 18. MOUNTING HEIGHT SHALL BE AS FOLLOWS:
 - A. LIGHTING SWITCHES
 B. CONVENIENCE OUTLETS
- 1.40M FROM CENTER OF DEVICE TO FINISHED FLOOR LEVEL 0.30M FROM CENTER OF DEVICE TO FINISHED FLOOR LEVEL
- ANELBOARD 1.80M FROM TOP OF PANEL TO FINISHED FLOOR LEVEL
- 18. SECURING OF NECESSARY ELECTRICAL PERMITS, CEI, AND OTHER NECESSARY REQUIREMENTS SHALL BE PART OF THE GENERAL CONTRACTOR INCLUDING COORDINATION/APPLICATION WITH THE UTILITY COMPANY FOR POWER INTERRUPTION.
- ALL WORKS SHALL BE EXECUTED IN A WORKMANSHIP MANNER AND SHALL PRESENT A NEAT AND ORDERLY ACCEPTANCE. ALL WIRING SHALL BE CONCEALED AS MUCH AS POSSIBLE.

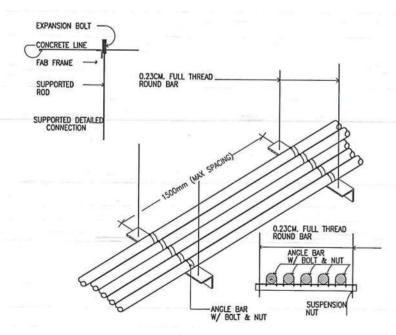


CONDUIT ARRANGEMENT

LEGEND

- 6 INCHES RECESSED TYPE VERTICAL LAMP DOWNLIGHT WITH FULL FROSTED GLASS
 COVER, POWDER COATED WHITE FINISH STEEL HOUSING AND MIRRORIZED ALUMINUM
 REFLECTOR WITH 1-12WATTS LED BULB; LETTER DENOTES CONTROL/SWITCH.
- 18 WATTS LED T8 BATTEN FIXTURE, 220-240V, 6500K DAYLIGHT, 1980 LUMENS;
 LETTER DENOTES CONTROL/SWITCH.
- DUAL OPTICS EMERGENCY LIGHT, 2x5WATTS LED BULB 100V-240V 1200LM 6500K,
 ADJUSTABLE LAMP HEADS, WITH 6V 3.0Ah SEALED ACID BATTERY, 258mm x 255mm x 68mm,
- DUPLEX UNIVERSAL CONVENIENCE OUTLET WITH GROUND, 16A, 250V, WIDE SERIES, WITH DEVICE PLATE COVER
- 12 INCHES SQUARE CEILING MOUNTED EXHAUST FAN, 38 WATTS, 230 VOLTS
- ONE-GANG, ONE WAY SWITCH, 16A, 250V, WIDE SERIES, WITH DEVICE PLATE COVER; LETTER DENOTES LIGHTS BEING CONTROLLED
- TWO-GANG, ONE WAY SWITCH, 16A, 250V, WIDE SERIES, WITH DEVICE PLATE COVER; LETTER DENOTES LIGHTS BEING CONTROLLED
- THREE-GANG, ONE WAY SWITCH, 16A, 250V, WIDE SERIES, WITH DEVICE PLATE COVER; LETTER DENOTES LIGHTS BEING CONTROLLED
- PANEL BOARD (SEE SCHEDULE OF LOADS FOR DETAILS)
- CIRCUIT BREAKER (SEE SCHEDULE OF LOADS FOR THE RATING)
- -> LPP-01 CIRCUIT HOMERUN TO PANELBOARD

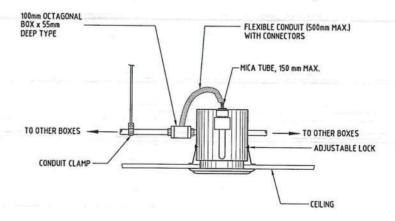

RECESSED DOWNLIGHT

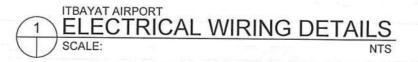





DEPARTMENT OF TRANSPORTATION
CIVIL AVIATION AUTHORITY OF THE PHILIPPIN
AERODROME DEVELOPMENT AND MANAGEMENT SERVIN

THIS DRAWING AND DESIGN IS EXCLUSIVE PROPERTIES OF CIVIL AVIATION AUTHORITY OF THE PHILIPPINES AND SUCH MUST NOT BE REPRODUCED, EXHIBITED, LOANED NOR COPIED IN PART OR IN WHOLE WITHOUT PROPER PERMISSION AND/OR WRITTEN CONSENT FROM THE DIRECTOR GENERAL CAAP.

AERODROME DEVELOPMENT AND MANAGEMENT SERVICE

INFRASTRUCTURE DEVELOPMENT AND DESIG

DESIGN STAFF:	INITIAL / DATE
DESIGNED BY:	IDDD /
DRAWN BY:	1000
REVIEWED BY:	

CHECKED BY



SUBMITTED BY:



RECOMMEND APPROVAL:

LT SOLVATENTINO A DIONELA PAF (RET)
Assistant Director General II, ADMS

APPROVED:

CAPTAIN MANUER MONIO L. TAMAYO
Director General

NOTES/REVISIONS.

IMPROVEMENT/REHABILITATION OF PASSENGER TERMINAL BUILDING OF ITBAYAT AIRPORT


LOCATIO


ITBAYAT, BATANES


SHEET CONTENTS:


ELECTRICAL WIRING DETAILS


DRAWING SCALE: SHEET NO:
E-1

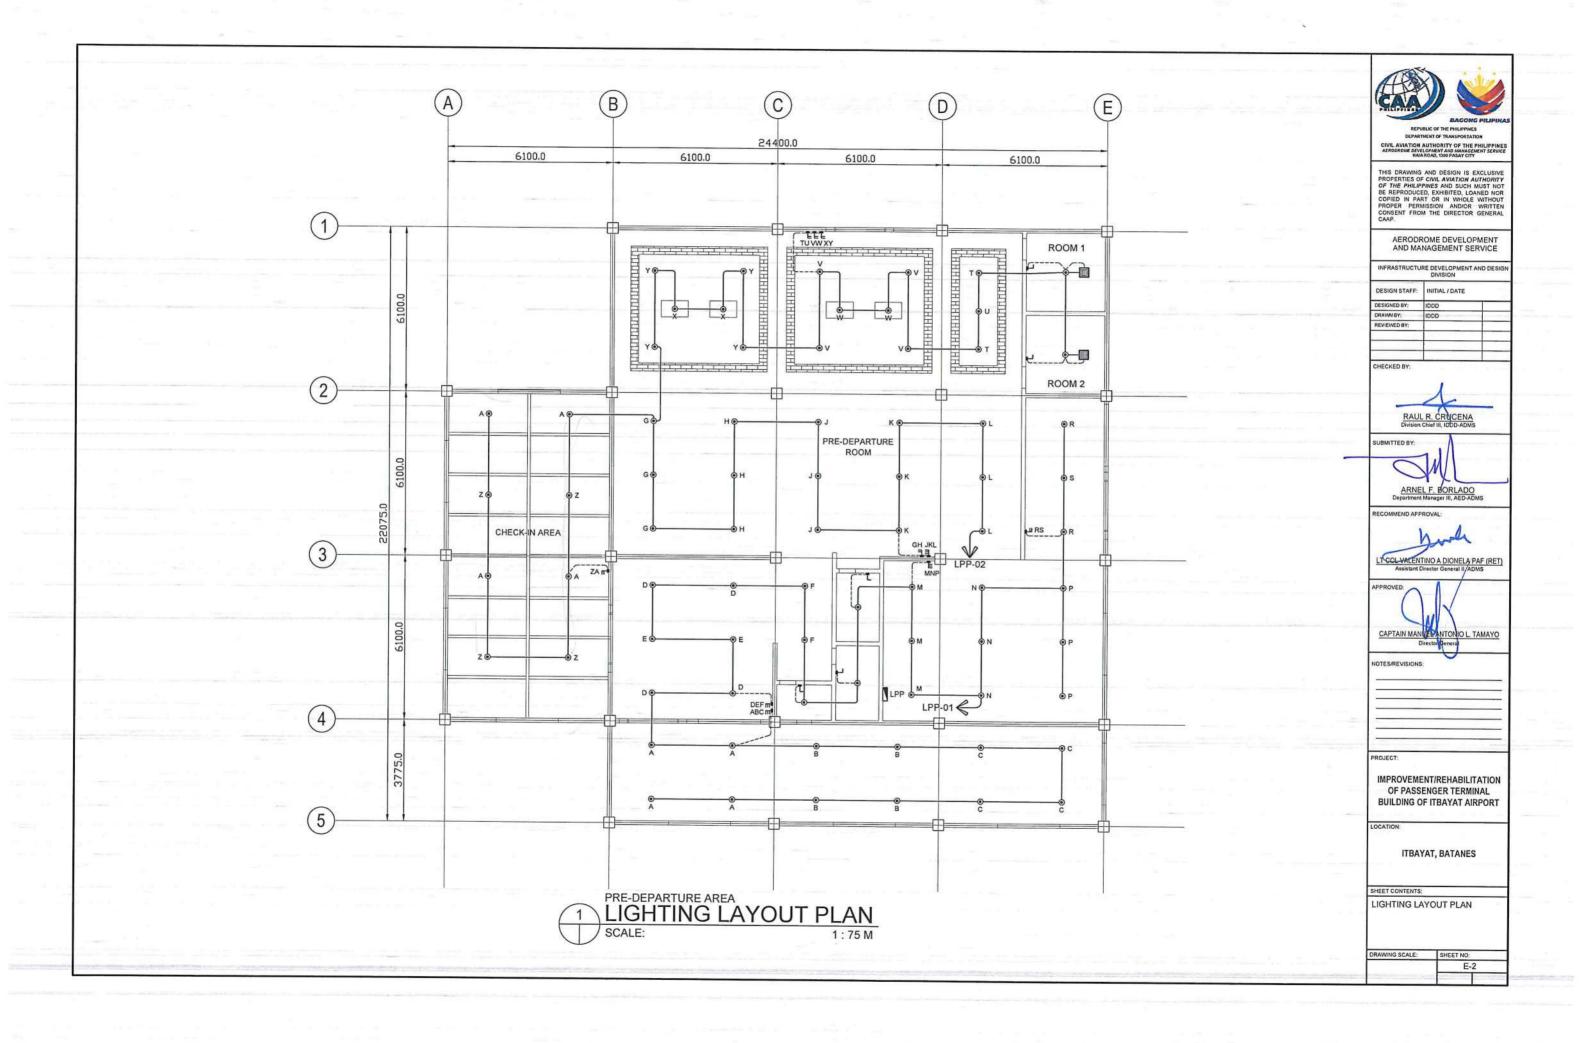

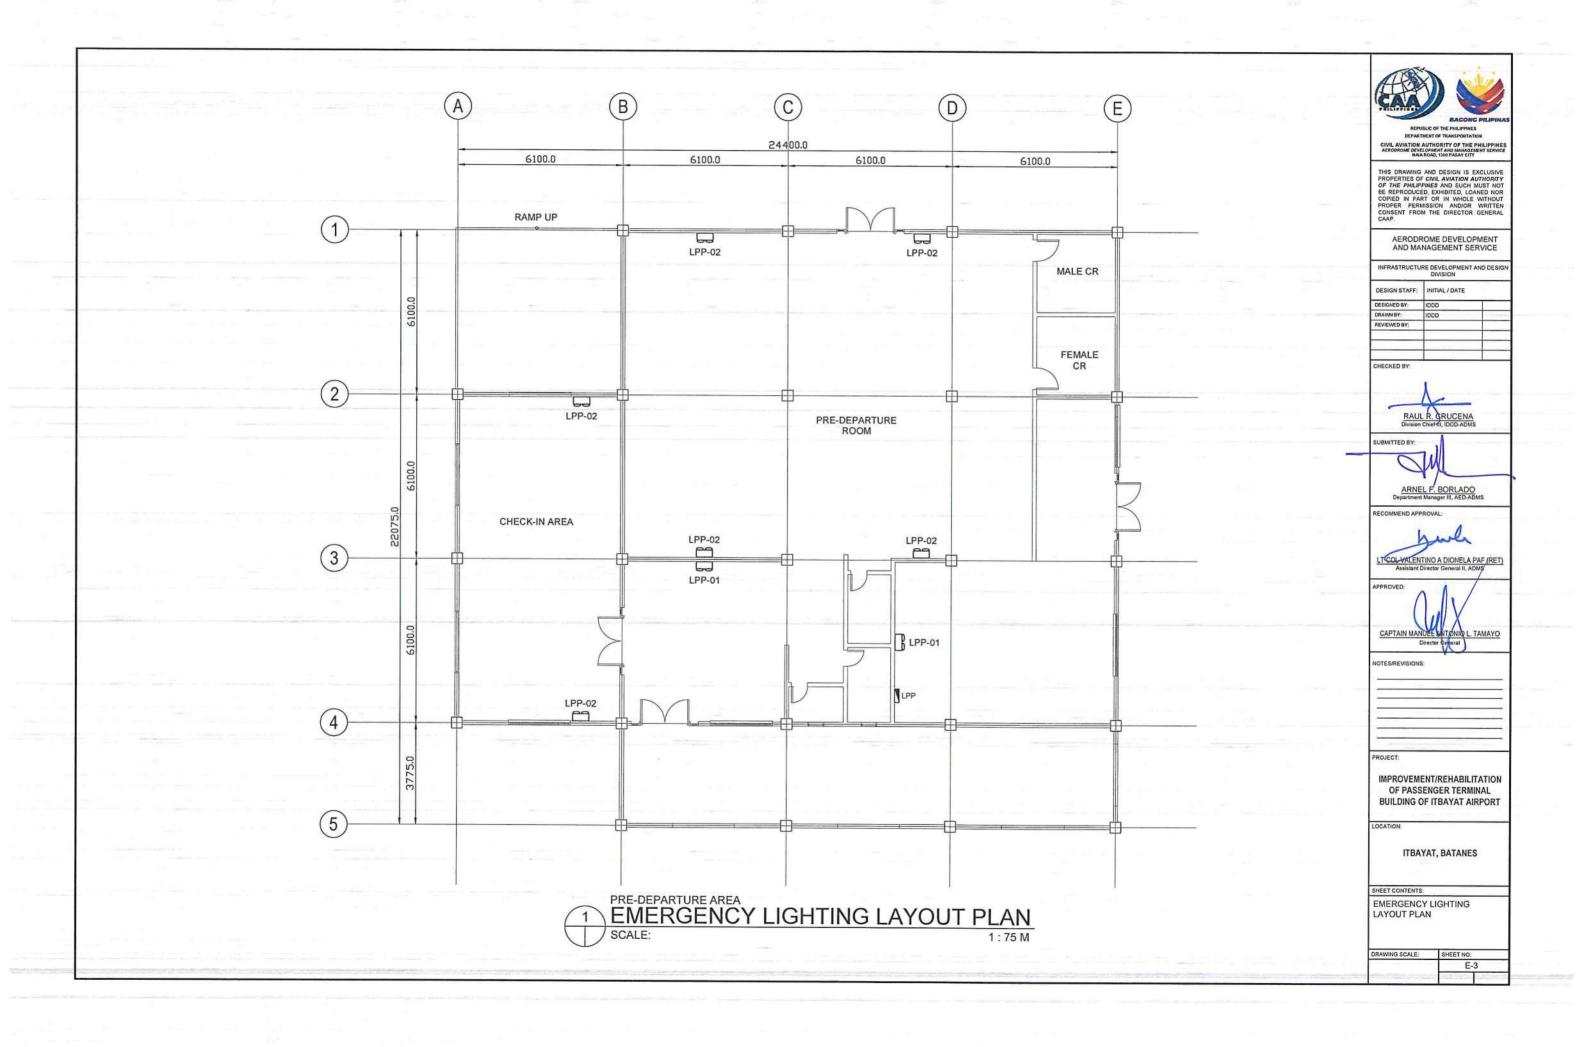


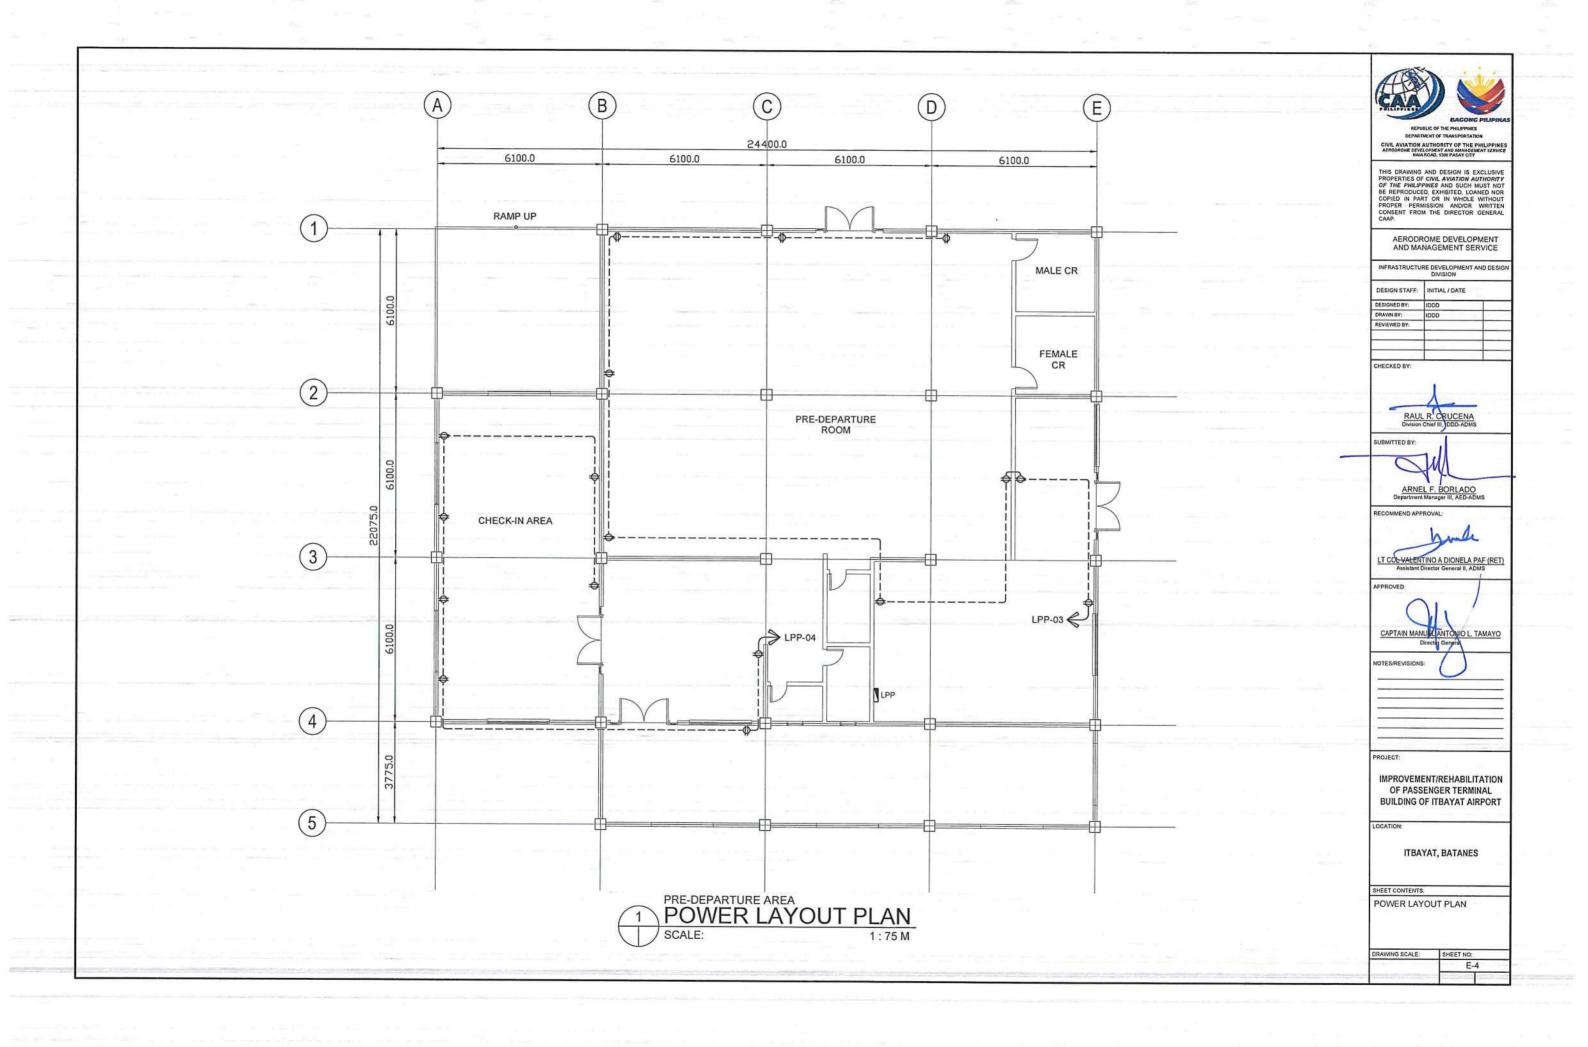


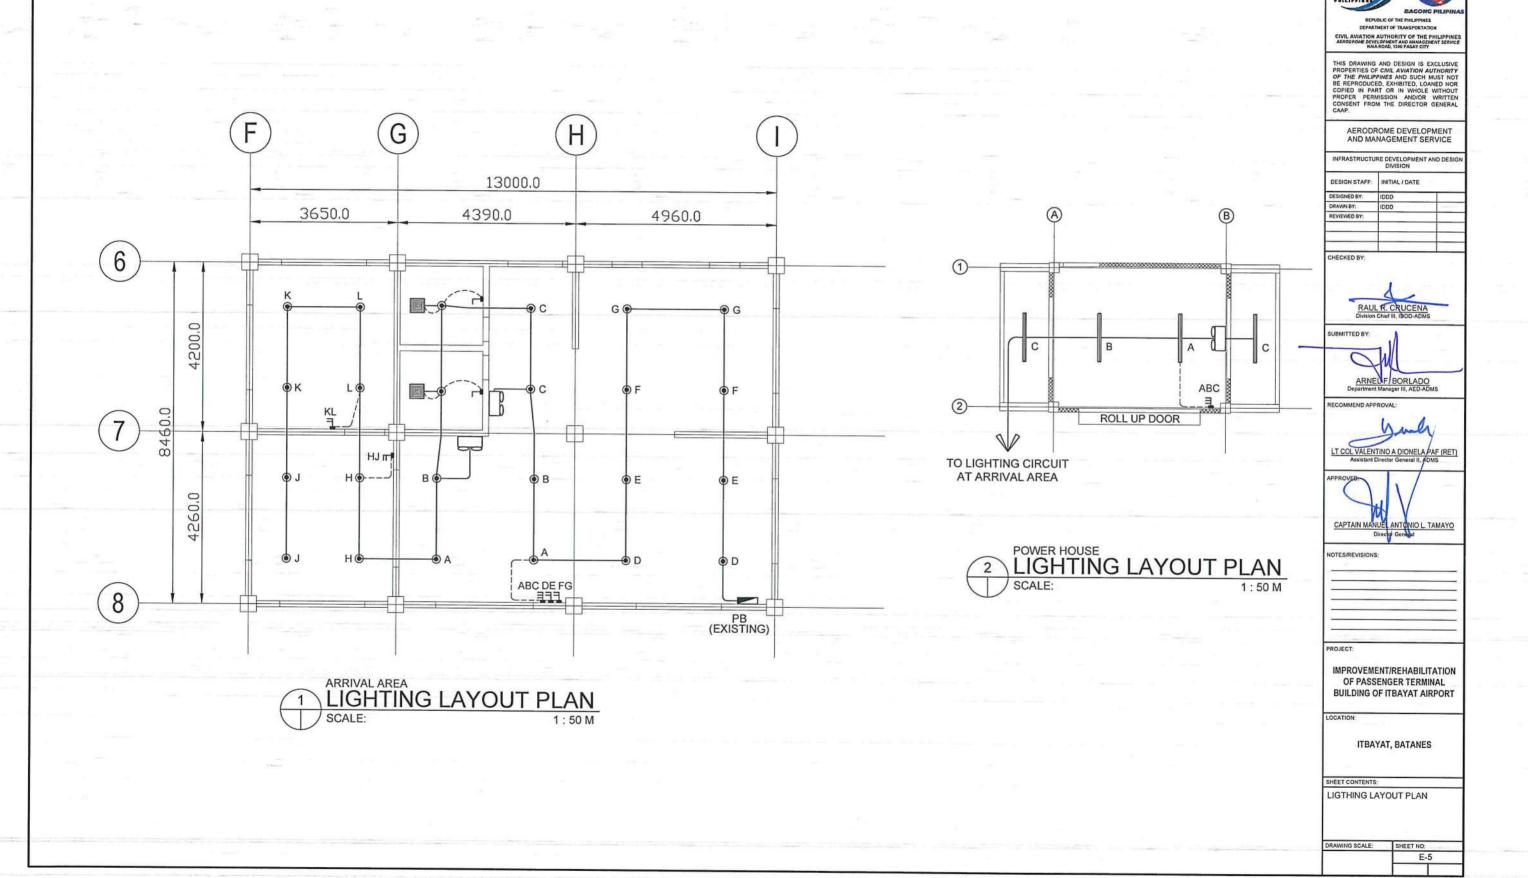


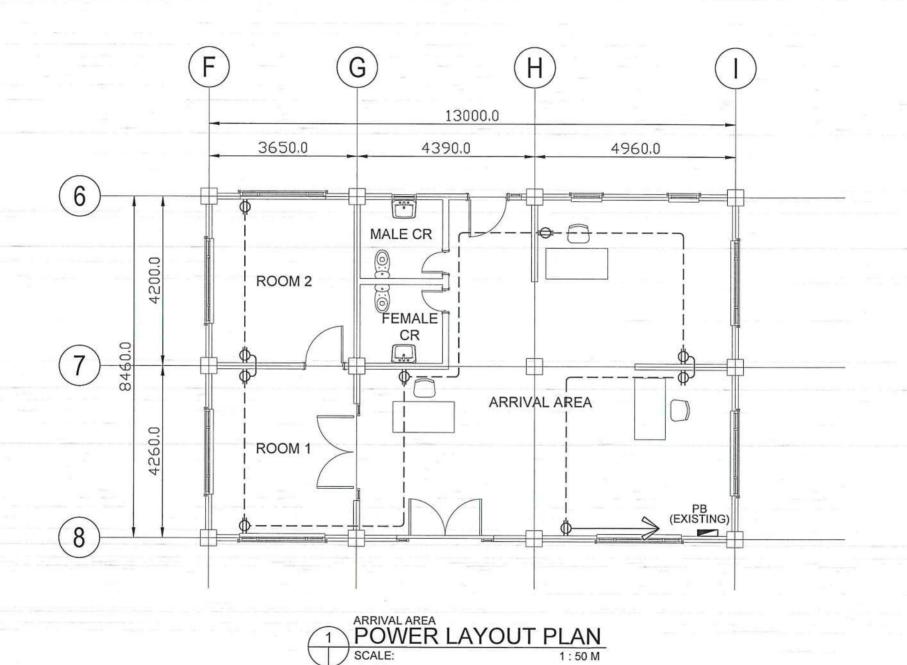





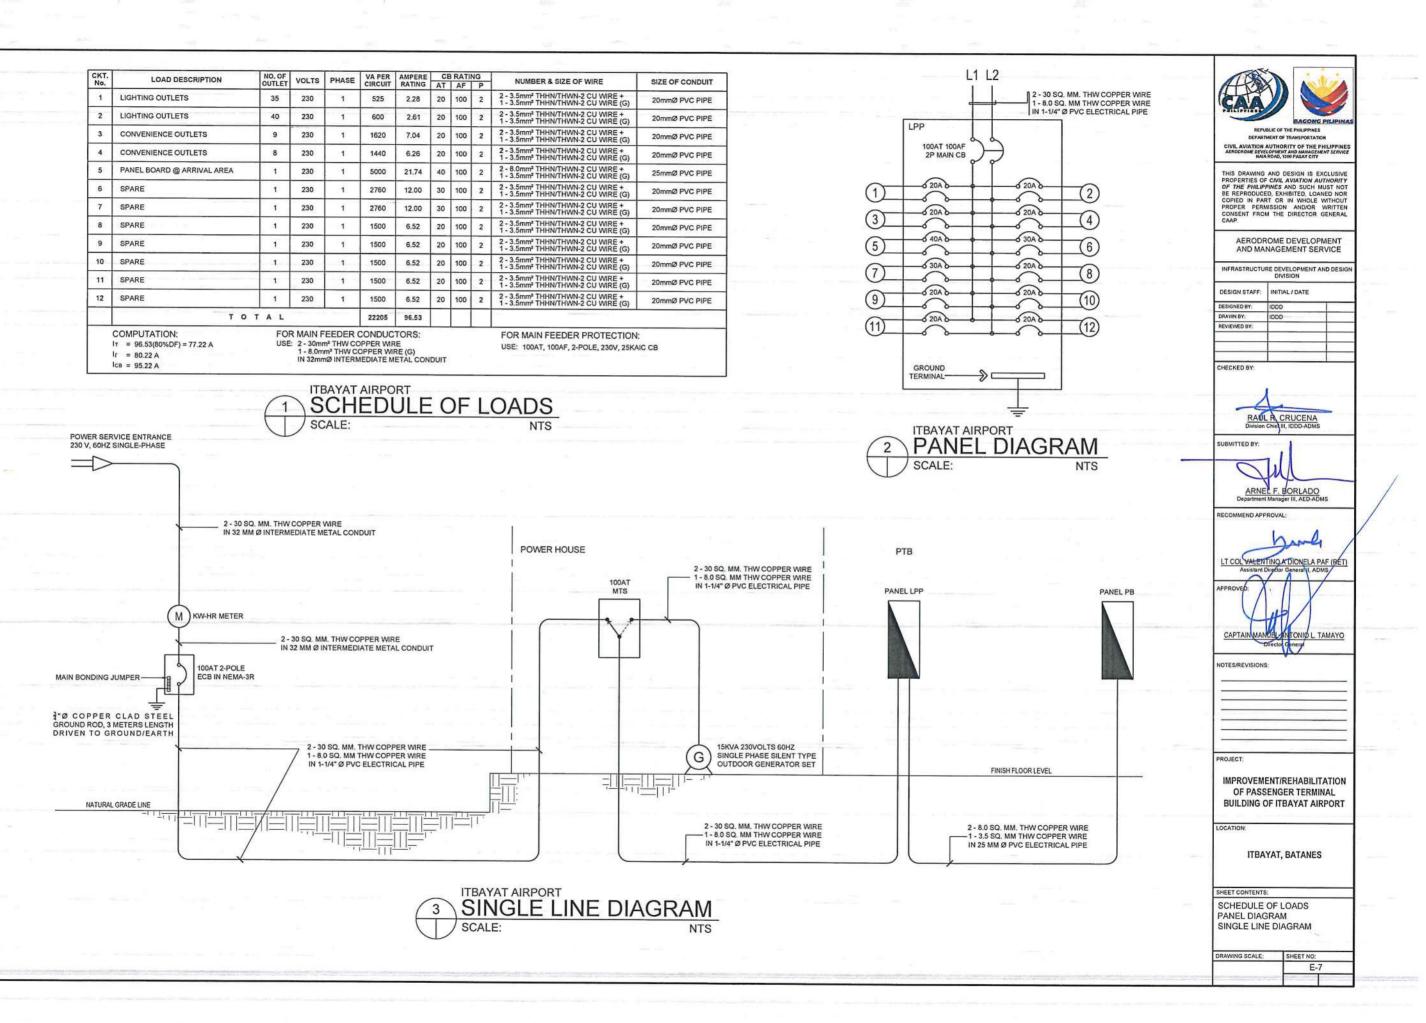


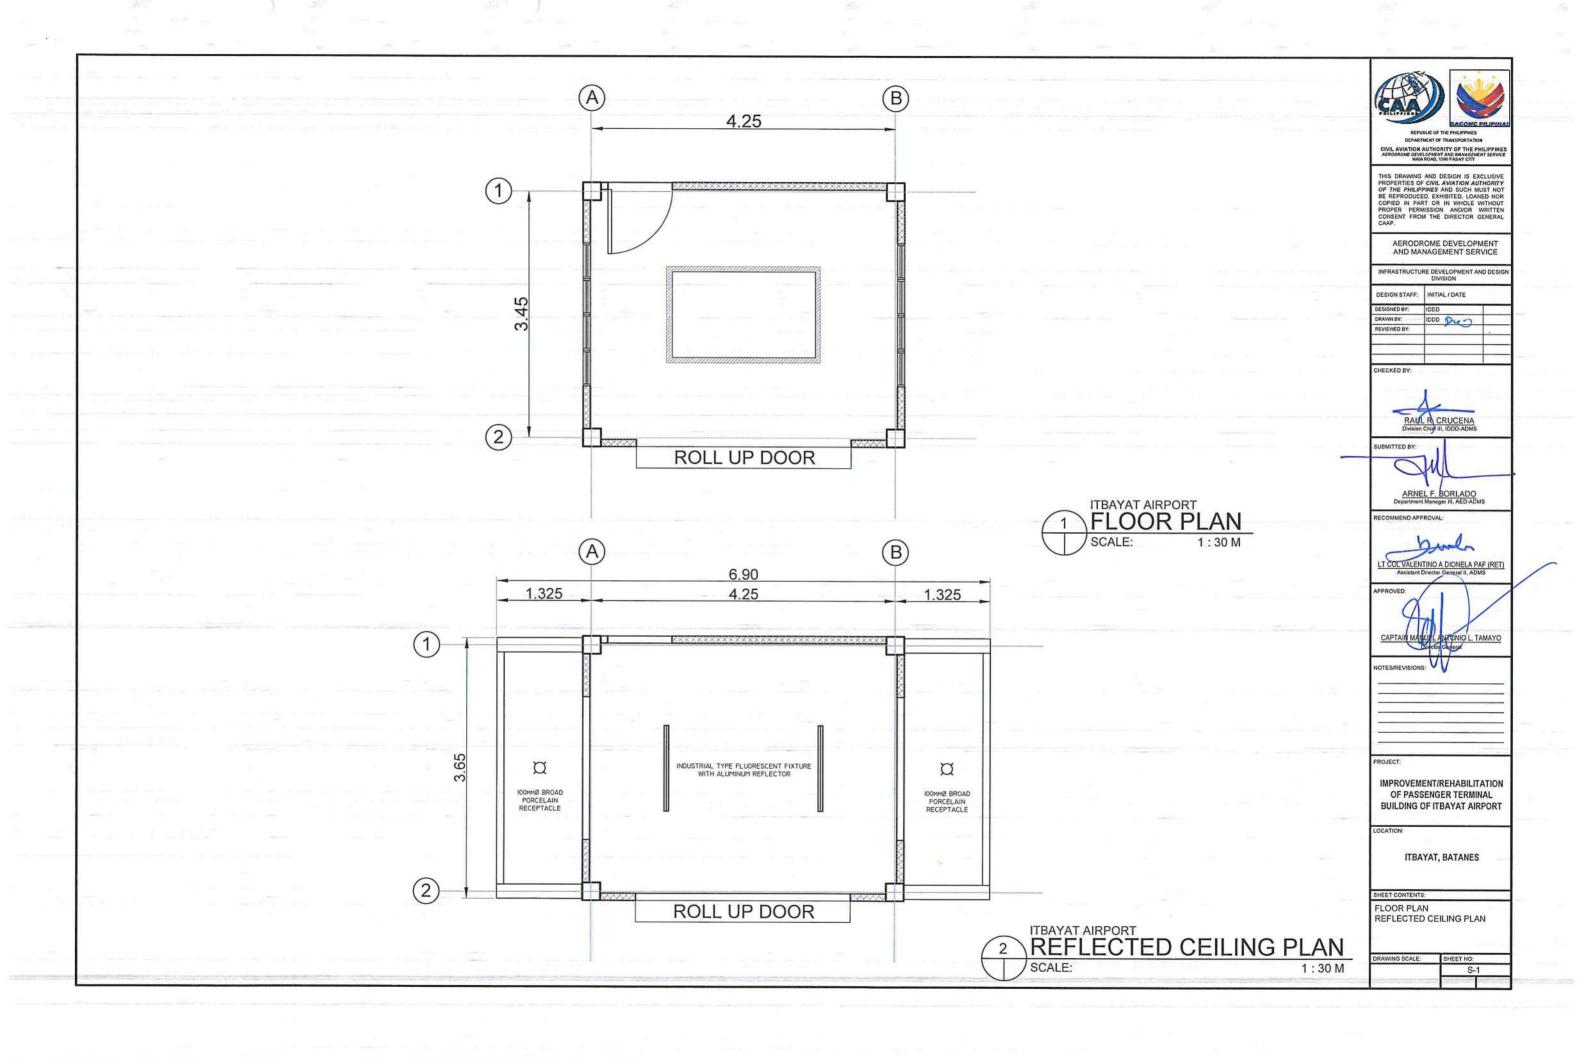


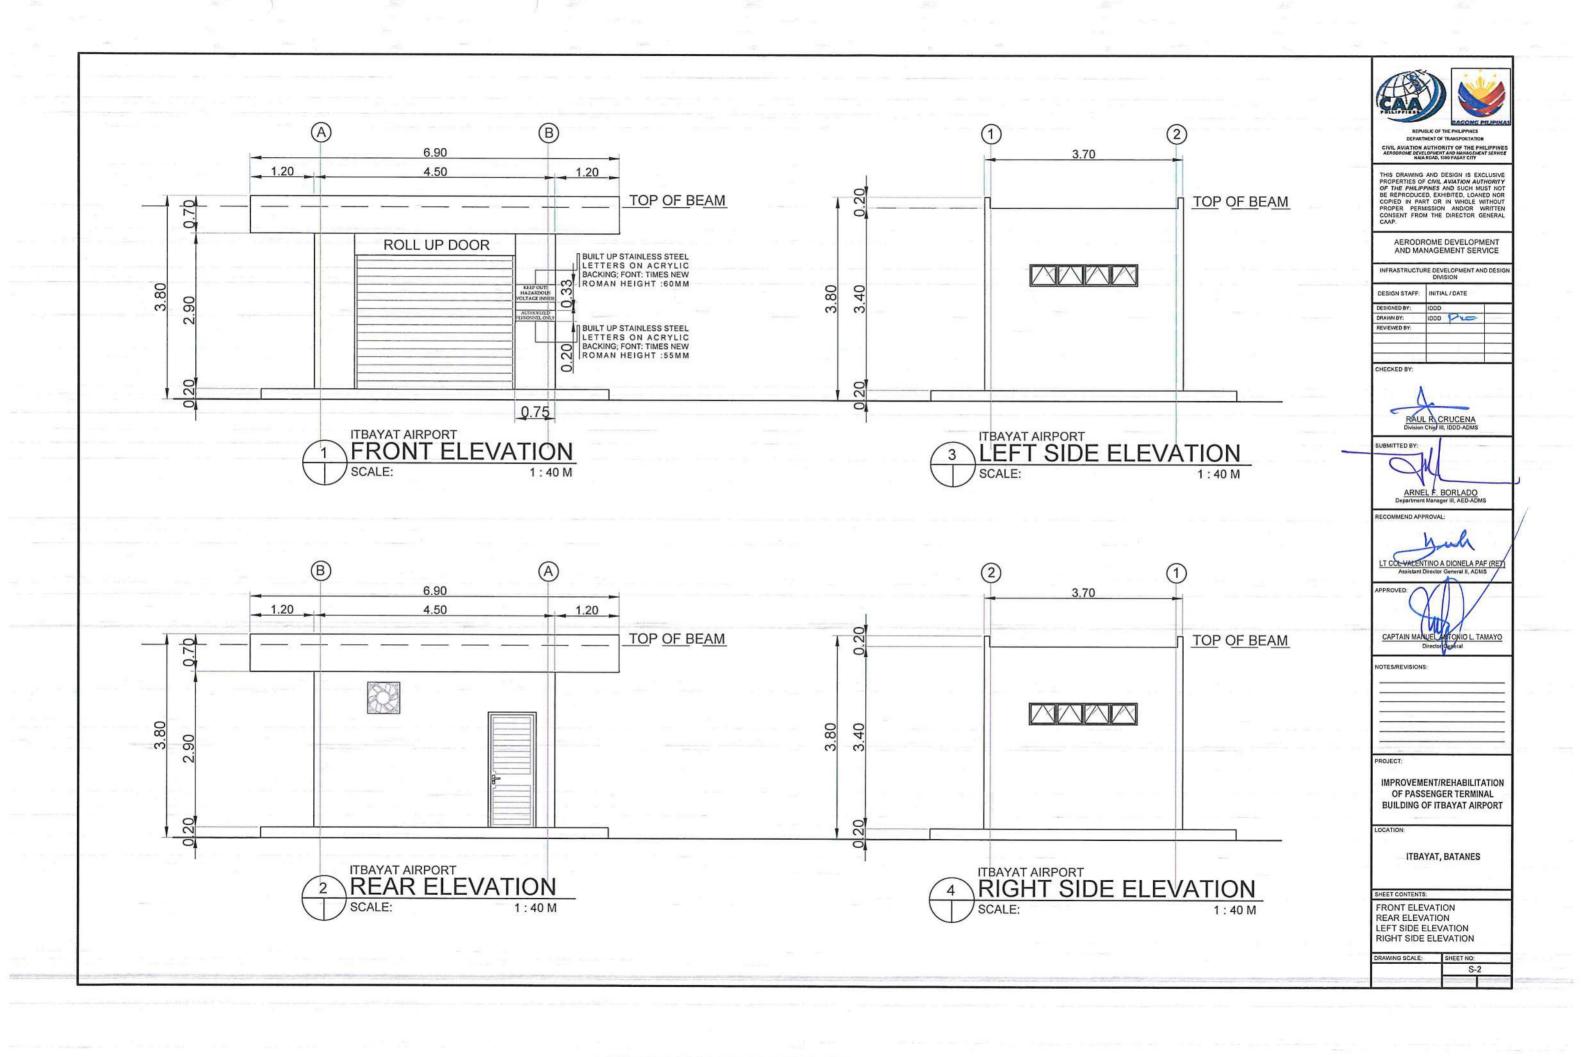


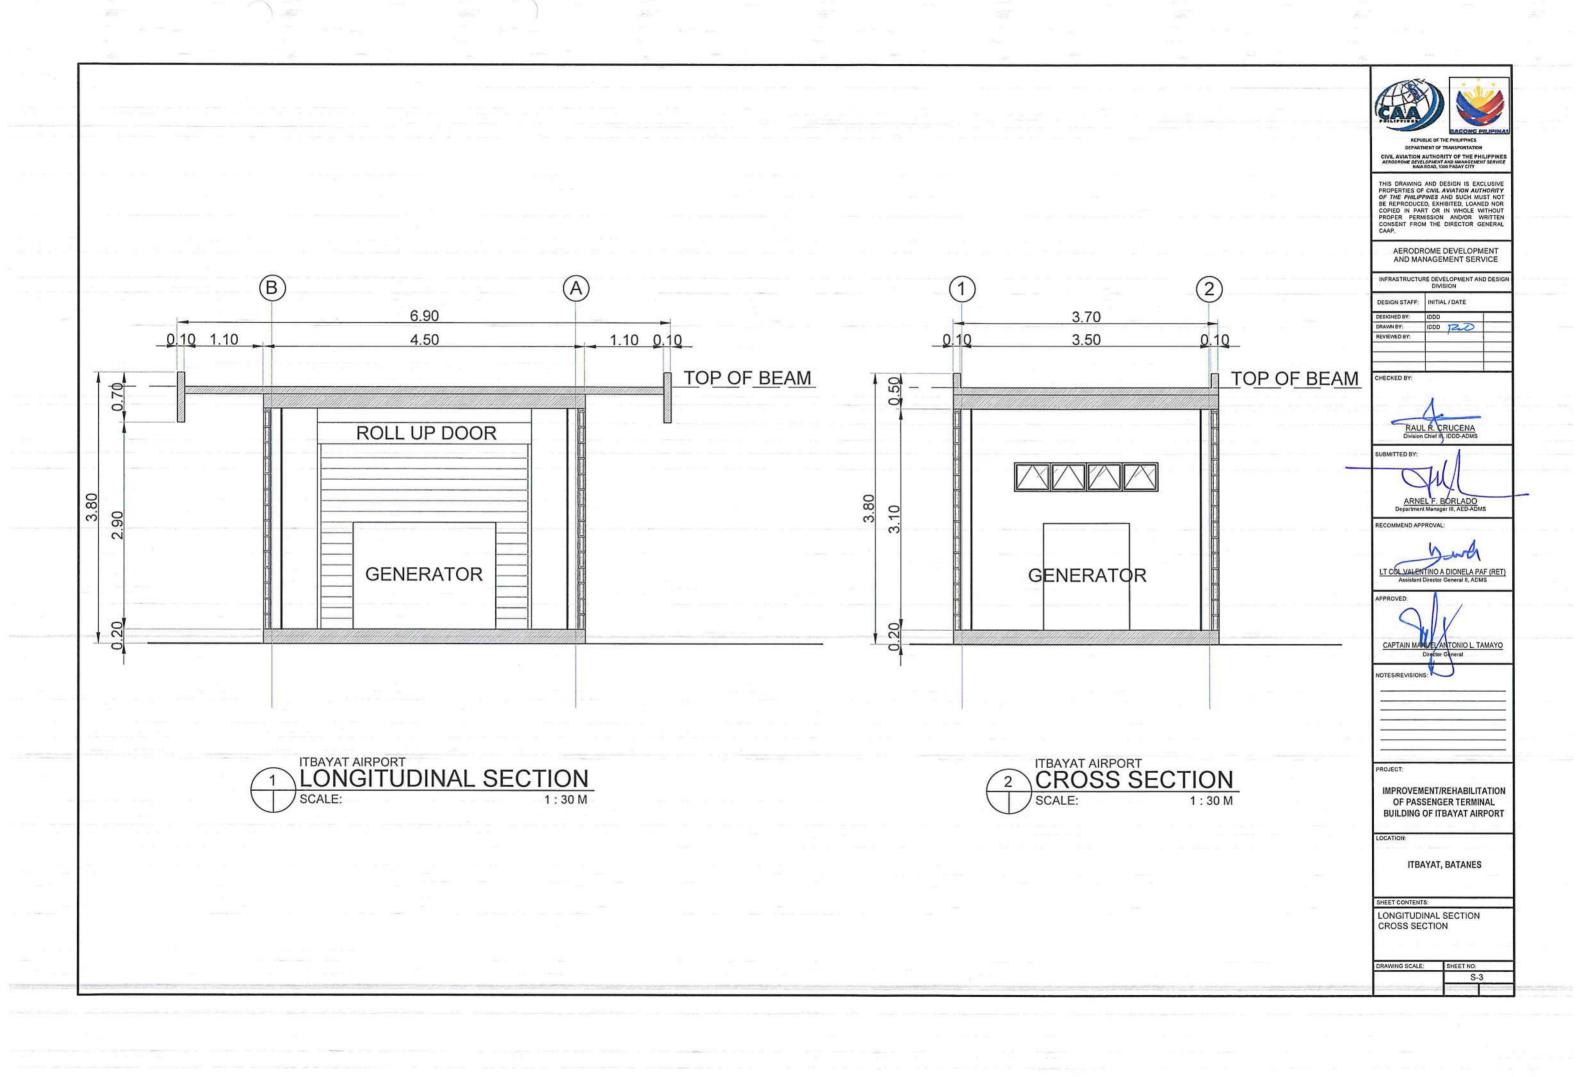

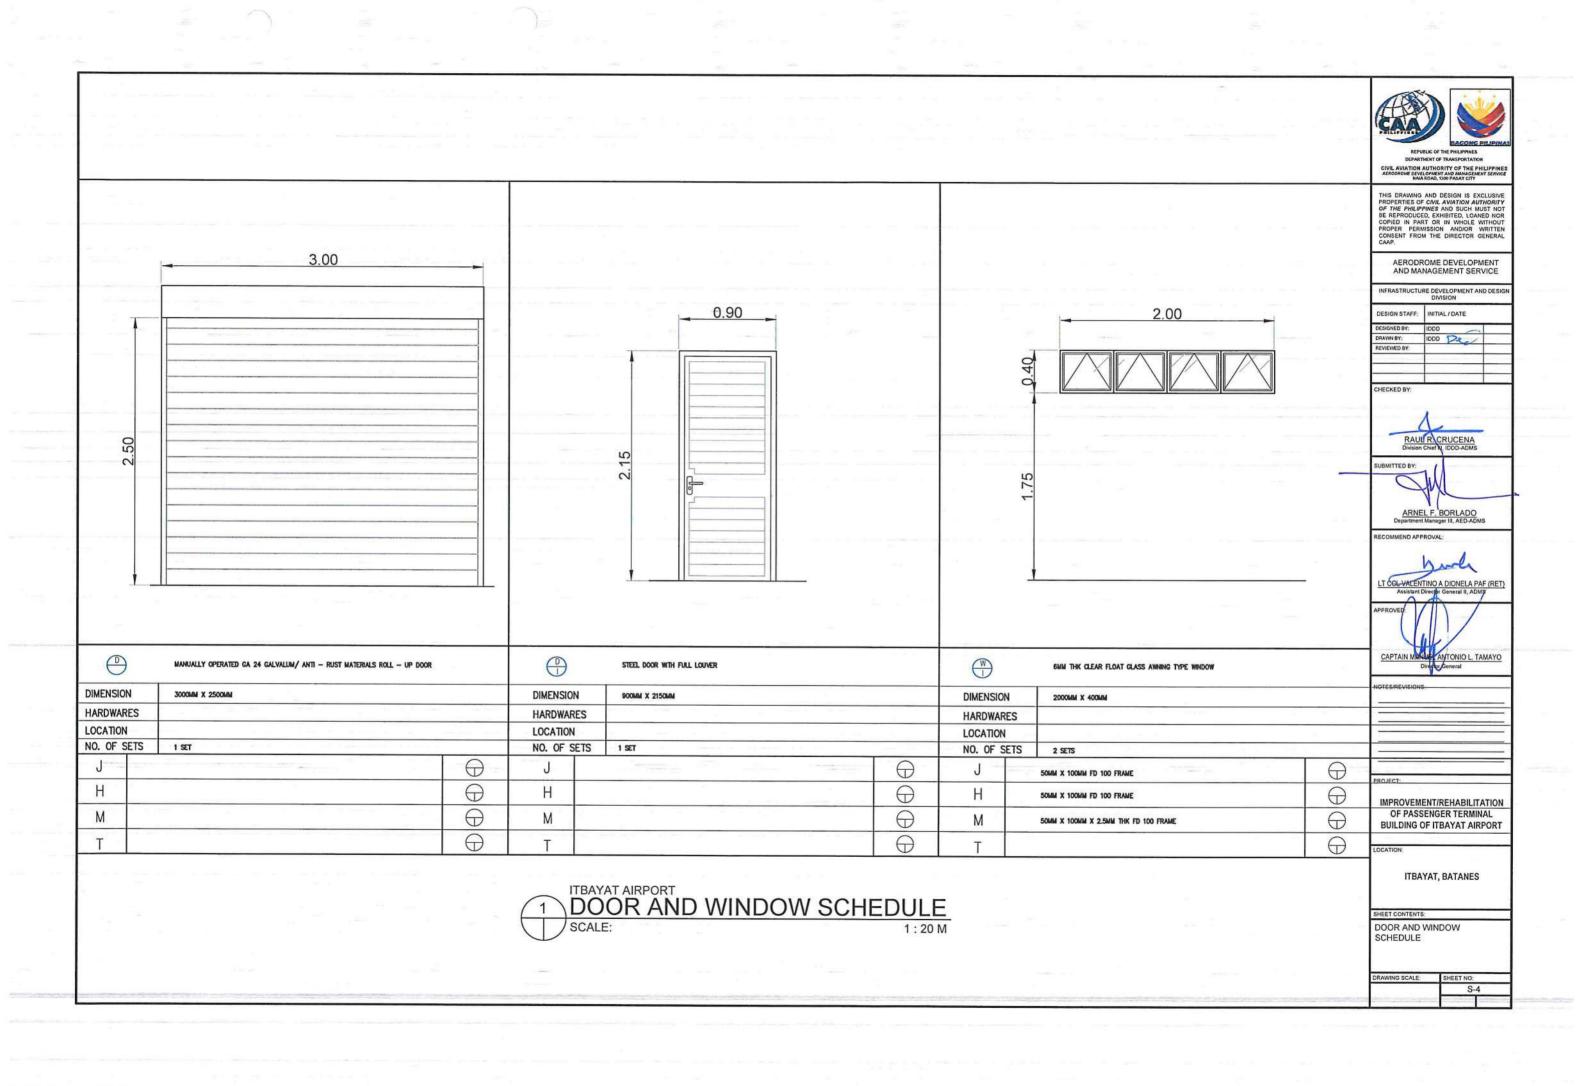

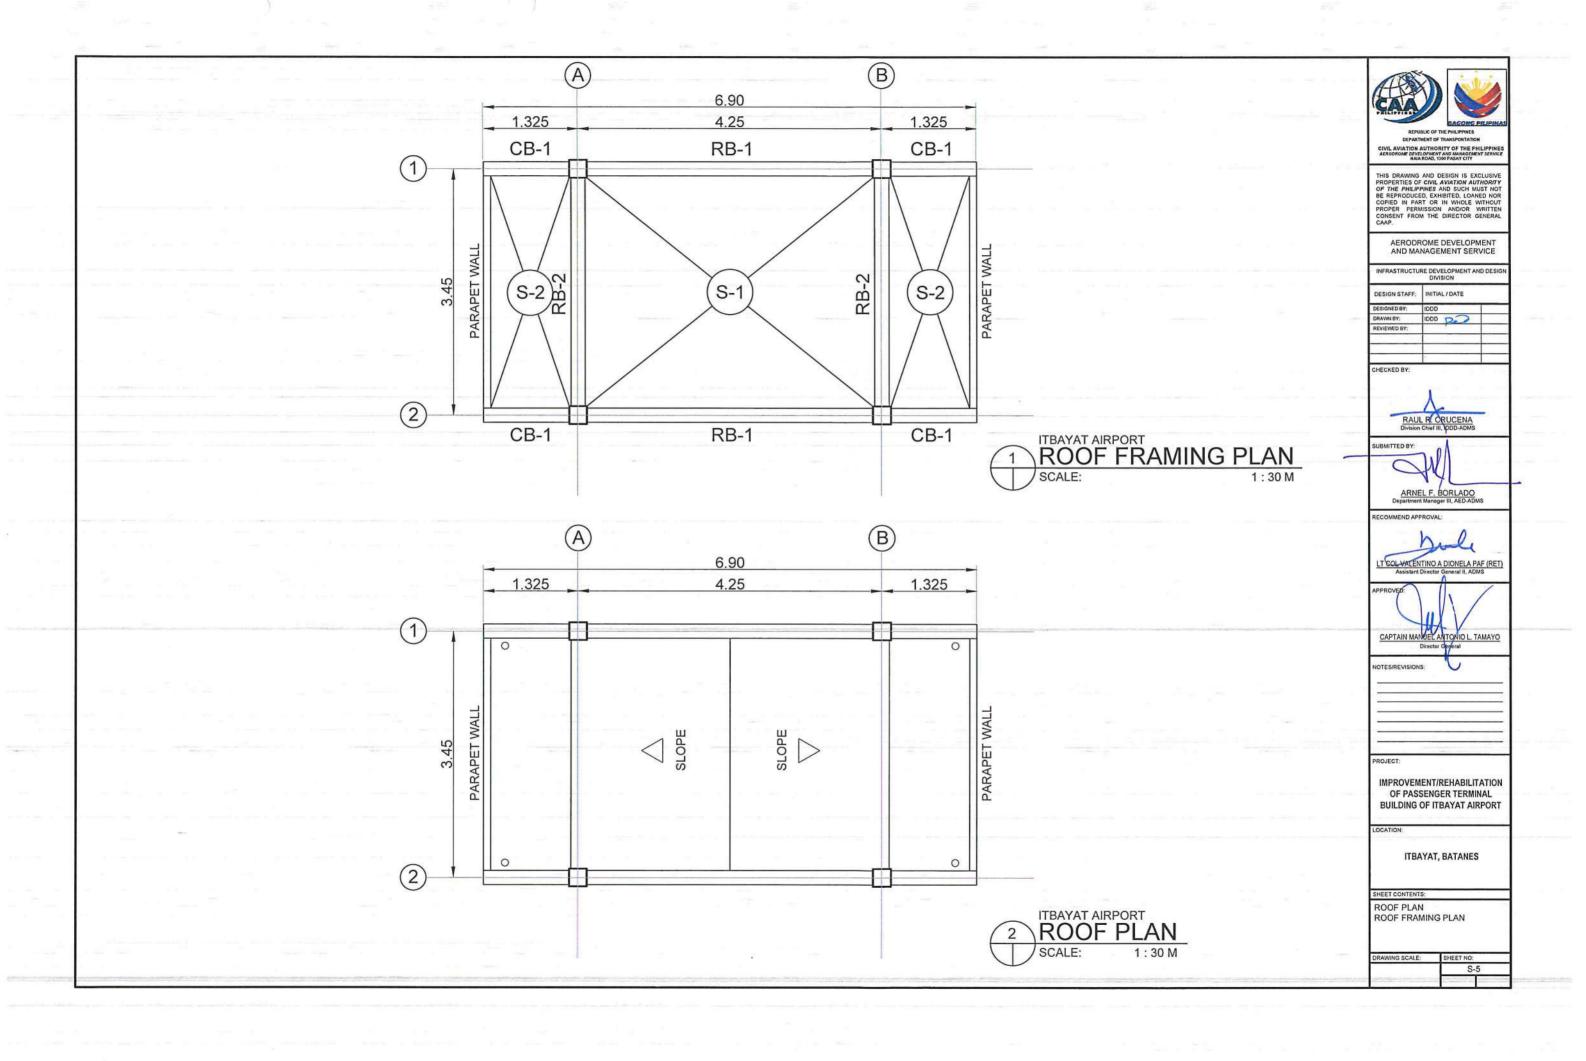

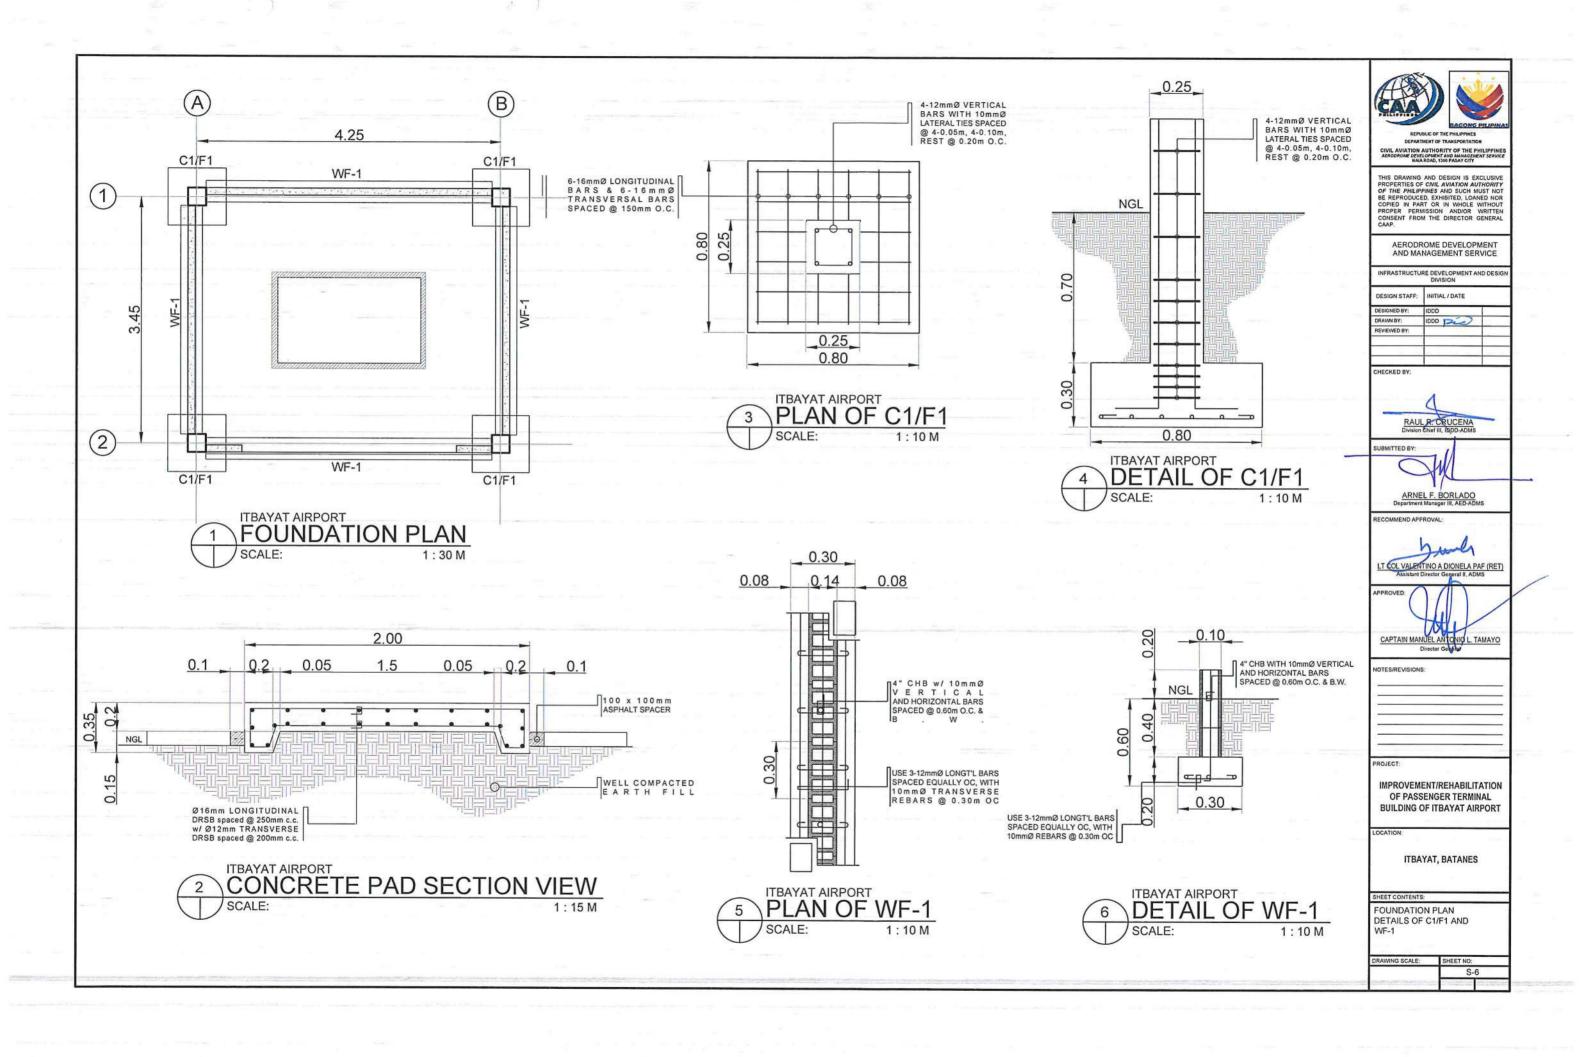


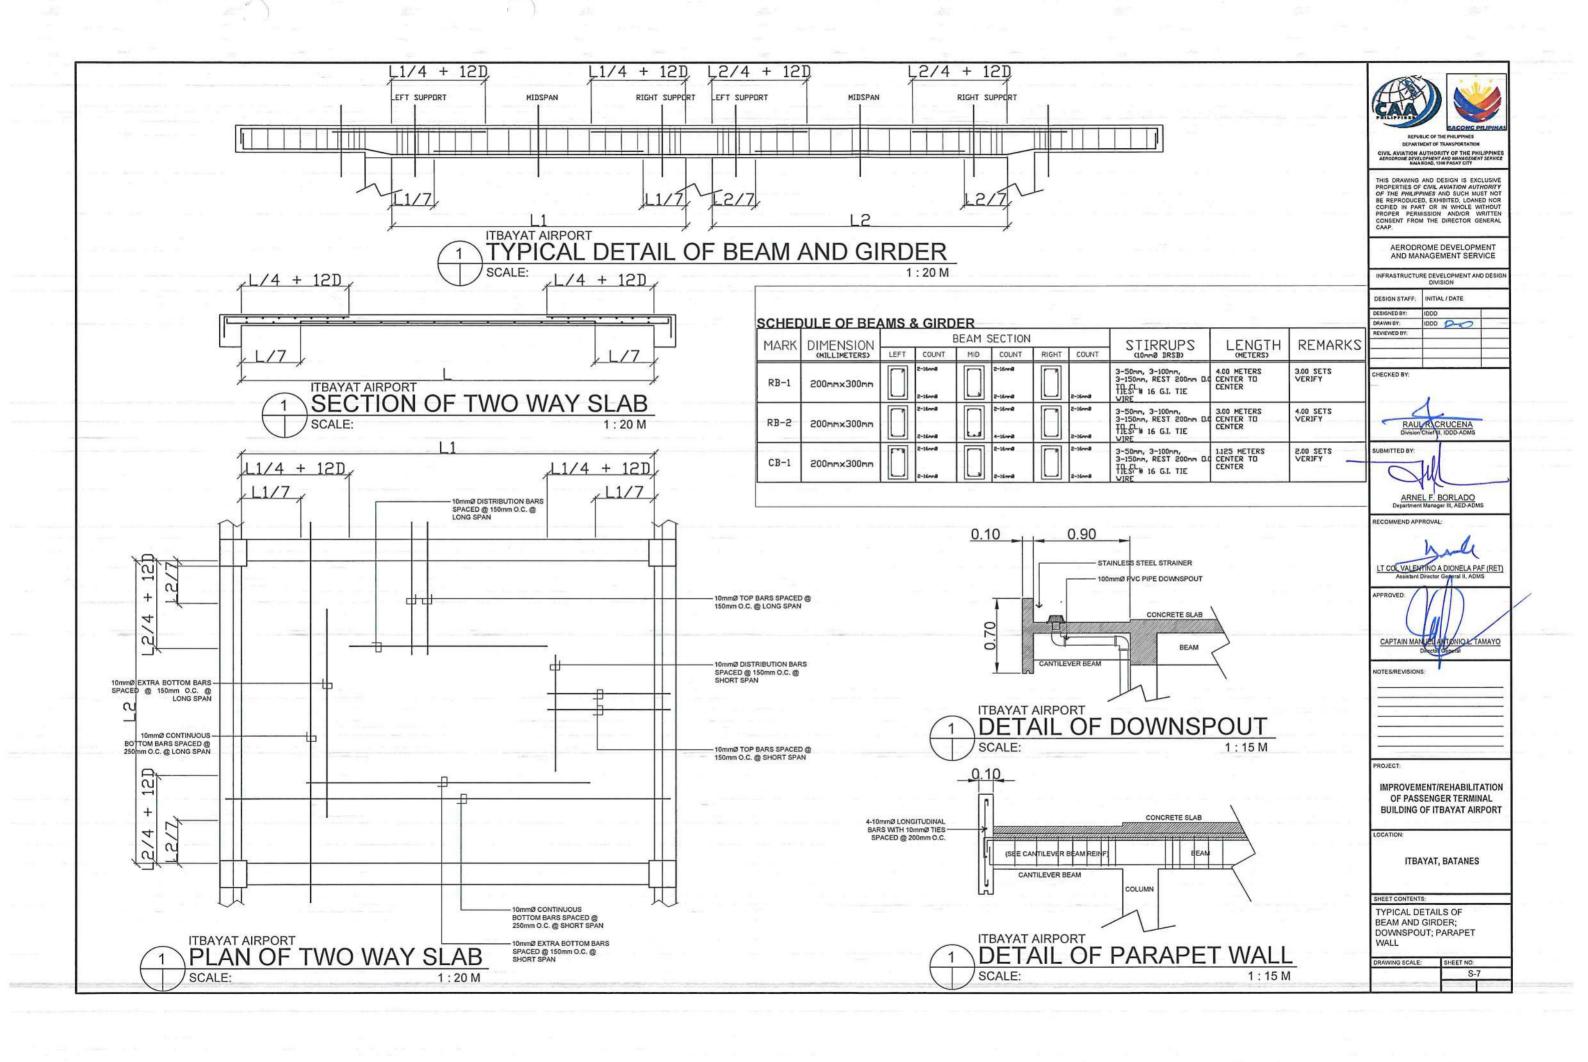

GENERAL NOTES:

- IT IS NOT INTENDED THAT THE DRAWINGS SHALL SHOW EVERY PIPE FITTINGS, DUCT FITTINGS, VALVES, DAMPERS, HANGERS/SUPPORTS, ETC.. ALL SUCH ITEM WHETHER SPECIFICALLY MENTIONED OR NOT, OR INDICATED ON THE DRAWINGS SHALL BE FURNISHED AND INSTALLED IF NECESSARY TO COMPLETE THE SYSTEM TO THE SATISFACTION OF THE ENGINEER AND THE OWNER.
- CONTRACTOR SHALL BE RESPONSIBLE IN VERIFYING AND COORDINATING, THE FOLLOWING IN ACCORDANCE WITH MANUFACTURER'S DATA AND RECOMMENDATIONS.
 - A. FLOOR, ROOF AND WALL OPENINGS
 - B. EQUIPMENT PADS/PEDESTALS
 - C. CONDENSATE DRAIN LINES
- 3. ALL PIPE SIZES ARE IN MILLIMETER (mm) UNLESS OTHERWISE INDICATED.
- ALL STRUCTURAL AND ARCHITECTURAL FINISHES DAMAGED DURING THE COURSE OF WORK SHALL BE RESTORED TO IT'S ORIGINAL CONDITION OR AS APPROVED BY OWNER.
- PROVIDE SERVICE ACCESS & CLEARANCE TO CHANGE AIR FILTER ELEMENT FOR AC EQUIPMENT AS RECOMMENDED BY MANUFACTURER.
- ALL INSULATED MECHANICAL PIPES THAT ARE EXPOSED SHALL BE CLADDED WITH ALUMINUM SHEET. CLADDING SHALL BE MACHINE/SHOP FABRICATED.
- CONTRACTOR/VENDOR SHOULD BE FAMILIAR WITH THE ACTUAL SITE CONDITION AND INSTALLATION TO VERIFY IF THE WORK IS IN CONFORMANCE TO MANUFACTURER RECOMMENDATION AND SHOULD RECTIFY IF SUCH CONDITION EXIST.
- THE CONTRACTOR SHALL COORDINATE W/ THE STRUCTURAL, SANITARY, ARCHITECTURAL AND ELECTRICAL REGARDING THE ROUGHING-INS OF FUTURE AIR CONDITIONING UNITS, ALL EMBEDDED ITEMS SHALL BE INSTALLED IN PLACE UNDER THIS CONTRACT.
- FINAL EOPT. TAG NUMBERING SHALL BE MADE BY THE OWNER'S ENGINEERING DEPARTMENT FOR CASE OF IDENTIFICATION OF INDIVIDUAL UNIT.
- INSTALLATION OF ALL WORKS SHALL BE DONE IN A NEAT AND WORKMANLIKE MANNER, IMPROPERLY SET WORK OR FINISH AS DETERMINED BY THE ARCHITECT SHALL BE REMOVED AND REPLACED AT NO EXTRA COST.
- 11. ALL MATERIALS TO BE USED SHALL BE BRAND NEW AND CLEAN.
- 12. DEVIATION AND REVISIONS FROM PLAN SHALL BE REFERRED TO THE ARCHITECT/ENGINEER FOR REVIEW AND APPROVAL.
- ALL NECESSARY GOVERNMENT PERMIT SHALL BE SECURED AND PAID FOR THE CONTRACTOR.
- ALL MECHANICAL WORKS SHALL BE IN ACCORDANCE WITH THE LATEST MECHANICAL ENGINEER'S CODE ASVE, ASHRAE AND SMACNA STANDARD.
- ALL A/C AND VENTILATING EQUIPMENT CONTROL PANEL SWITCH AND CIRCUIT BREAKERS ARE PROVIDED BY THE MECHANICAL CONTRACTOR.
- THE MECHANICAL CONTRACTOR SHALL CONDUCT TESTING, BALANCING AND COMMISSIONING OF ALL A/C AND VENTILATING EQUIPMENT.

SYMBOL	ABBREVIATION	DESCRIPTION
14	A/C	AR CONDITIONING
出	ACCU	AIR COOLED CONDENSING UNIT
\ominus		EQUIPMENT TAG NUMBER
	FCU	FAN COL UNIT
	FDAS	FIRE DETECTION AND ALARM SYSTEM
	KW	KILOWATTS
	PH	PHASE
Θ		PIPE COING UP
c——		PIPE GOING DOWN
Æ.	PFE	PORTABLE FIRE EXTINGUISHER
	YTD	QUANTITY
	RL	REFRIGERANT LIQUID
	RG	REFRIGERANT GAS
	SMACHA	SHEET METAL AND AIR CONDITIONING CONTRACTORS NATIONAL ASSOCIATION
	TR	TON OF REFRIGERATION
	TYP	TYPICAL
	HP	HORSEPOWER
	HZ	HERTZ
	V	VOLTS

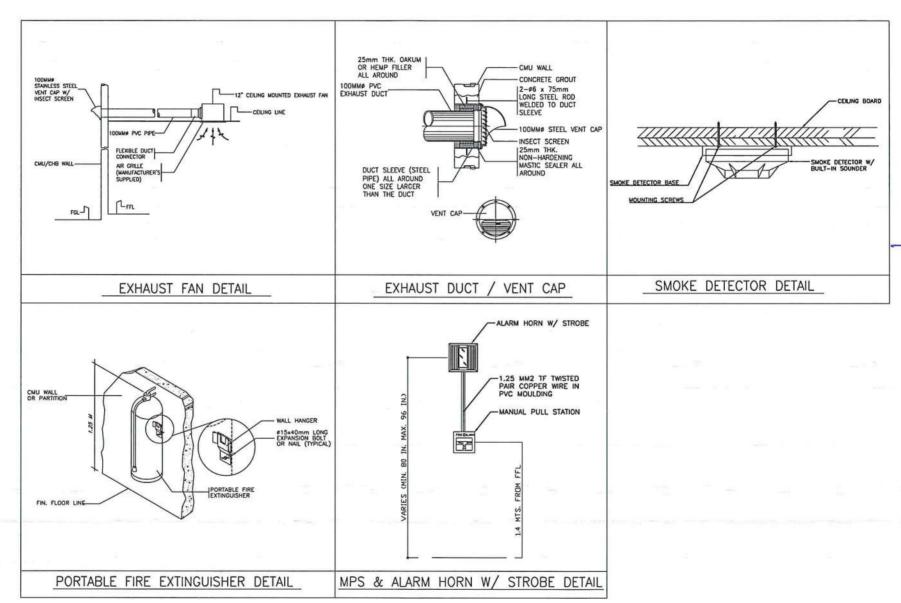





REPUBLIC OF THE PHILIPPINES

DEPARTMENT OF TRANSPORTATION

CIVIL AVIATION AUTHORITY OF THE PHILIPPINES

AERODROME DEVELOPMENT AND MANAGEMENT SERVICE

THIS DRAWING AND DESIGN IS EXCLUSIVE PROPERTIES OF CIVIL AVAITION AUTHORITY OF THE PHILIPPINES AND SUCH MUST NOT BE REPRODUCED, EXHIBITED, LOANED NOR COPIED IN PART OR IN WHOLE WITHOUT PROPER PERMISSION AND/OR WRITTEN CONSENT FROM THE DIRECTOR GENERAL CAAP.

AERODROME DEVELOPMENT AND MANAGEMENT SERVICE

INFRASTRUCTURE DEVELOPMENT AND DESIGN DIVISION

DESIGN STAFF: INITIAL / DATE

DESIGNED BY: IDDD

DRAWN BY: JCMC

CHECKED BY: RUAJR

REVIEWED BY:



SUBMITTED BY:

ARNEL F. BORLADO

RECOMMEND APPROVAL:

LT COL-VALENTINO A DIONELA PAF (RET)
Assistant Director General II, ADMS

APPROVED:

CAPTAIN MANUEL ANTONIO L. TAMAYO

NOTES/REVISIONS:

IMPROVEMENT/REHABILITATION OF PASSENGER TERMINAL BUILDING OF ITBAYAT AIRPORT

LOCATION

ITBAYAT, BATANES

SHEET CONTENTS:


GENERAL NOTES


MISCELLANEOUS DETAILS

DRAWING SCALE: SHEET NO:

AS SHOWN

M-1

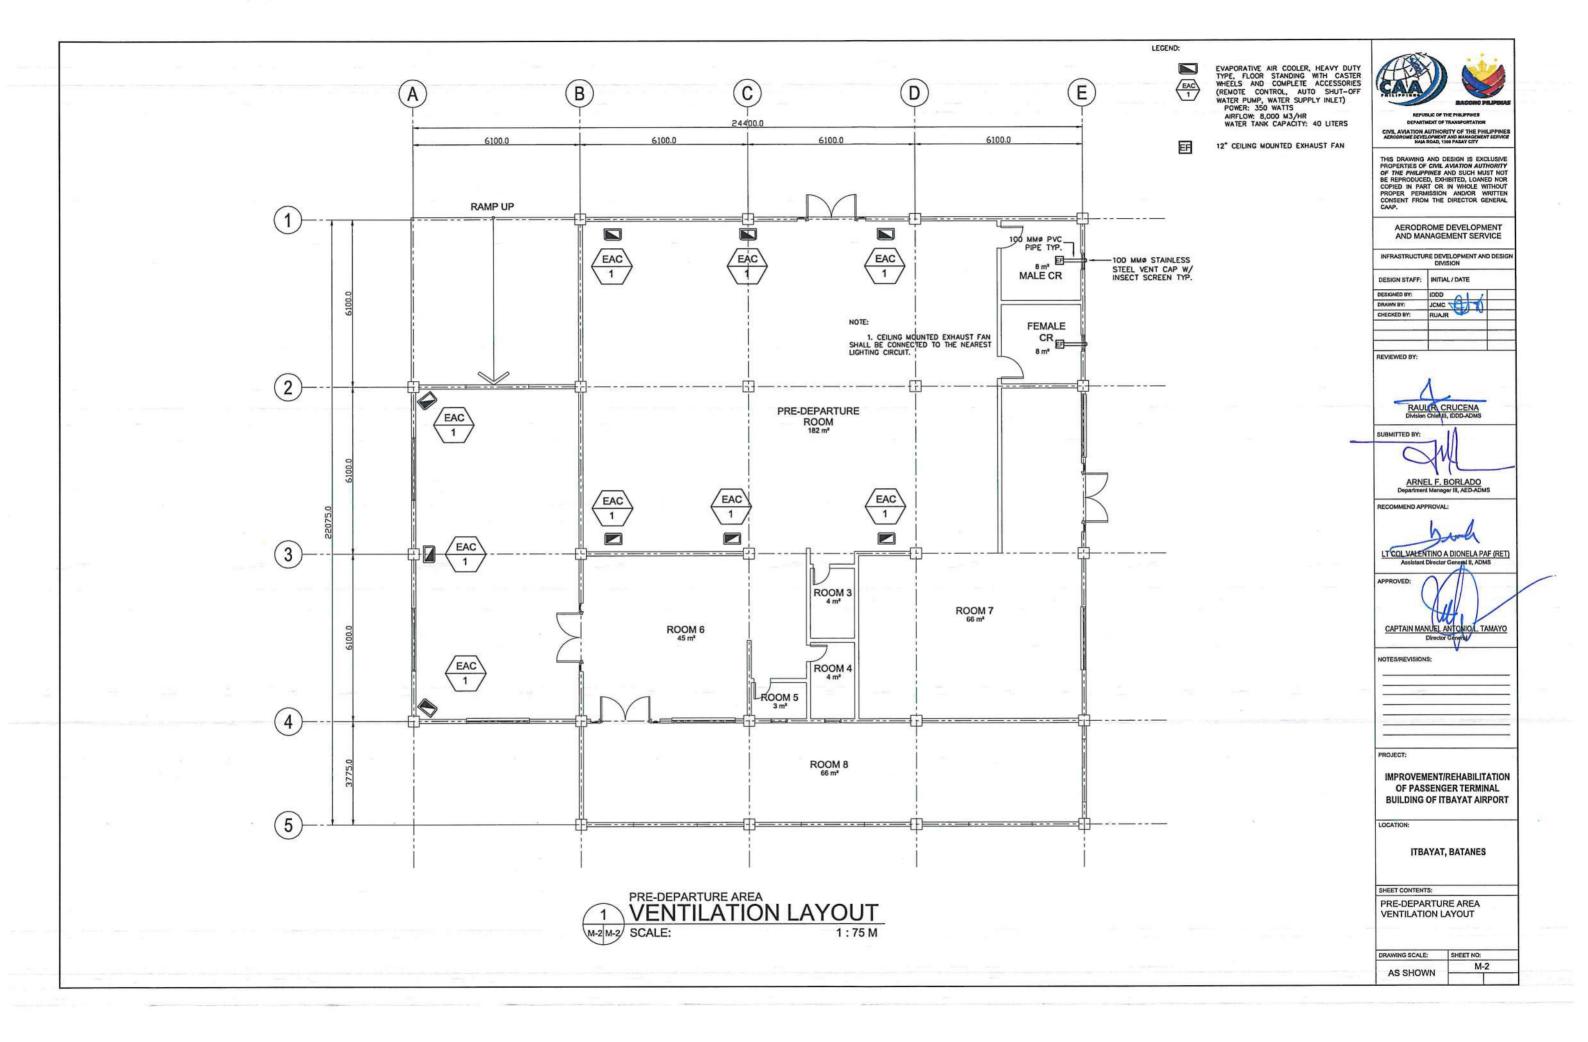

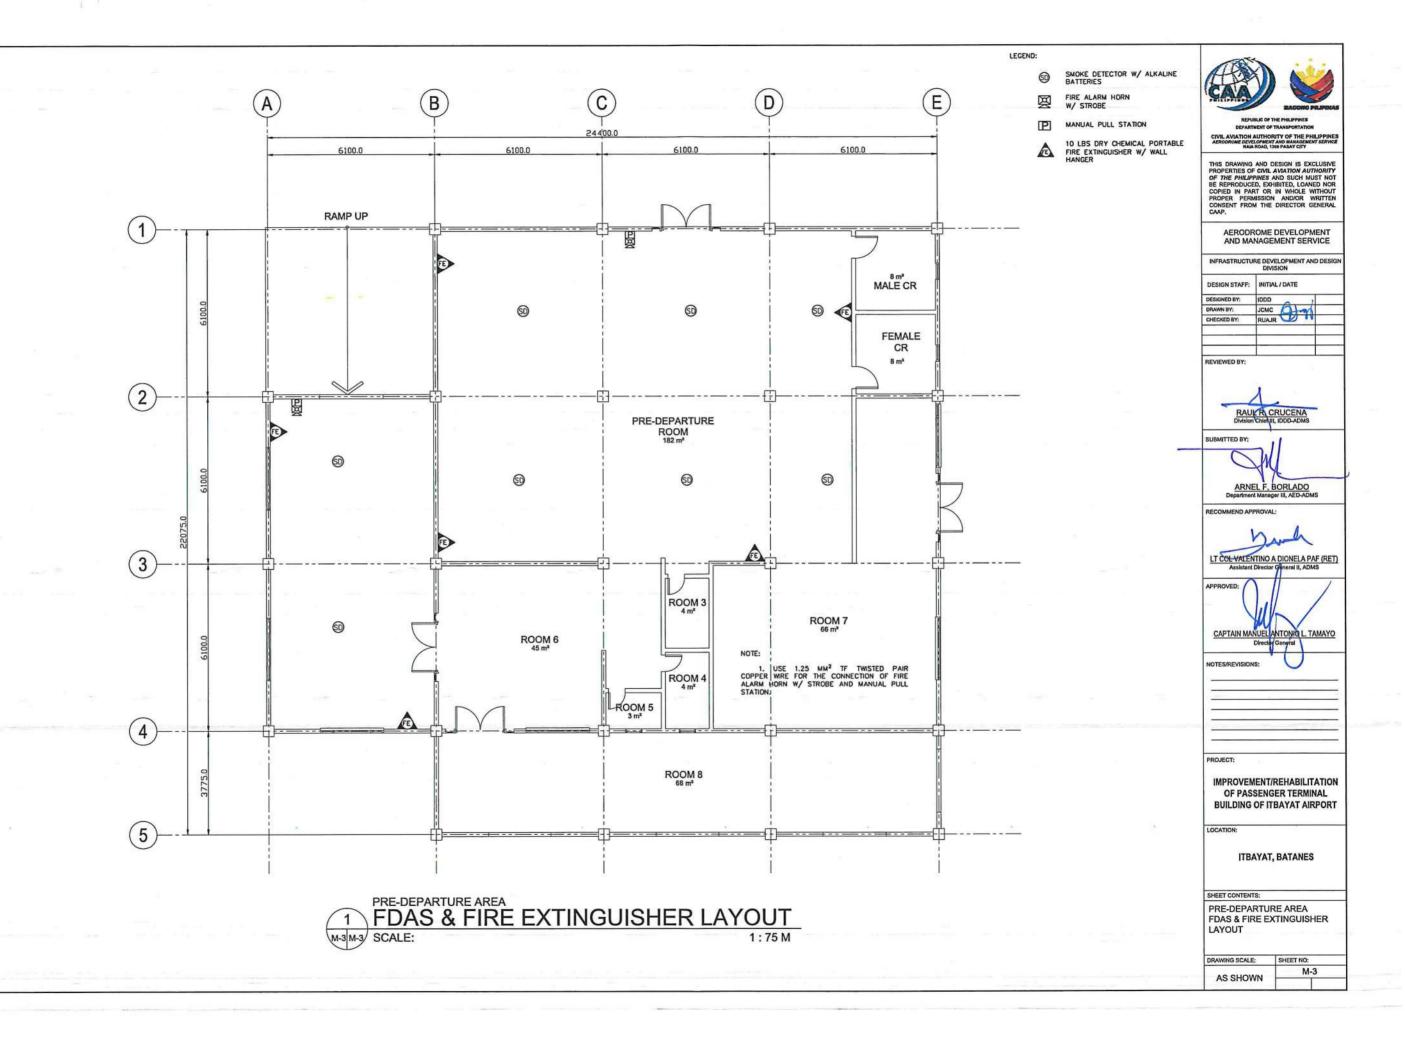

EVAPORATIVE AIR COOLER, HEAVY DUTY
TYPE, FLOOR STANDING WITH CASTER
WHEELS AND COMPLETE ACCESSORIES
(REMOTE CONTROL, AUTO SHUT-OFF
WATER PUMP, WATER SUPPLY INLET)
POWER: 350 WATTS
AIRFLOW: 8,000 M3/HR
WATER TANK CAPACITY: 40 LITERS

EF 12° CEILING MOUNTED EXHAUST FAN

LEGEND:

SD SMOKE DETECTOR W/ ALKALINE BATTERIES

FIRE ALARM HORN
W/ STROBE

MANUAL PULL STATION

10 LBS DRY CHEMICAL PORTABLE FIRE EXTINGUISHER W/ WALL HANGER





REPUBLIC OF THE PHILIPPINES
DEPARTMENT OF TRANSPORTATION
CIVIL AVIATION AUTHORITY OF THE PHILIP

THIS DRAWING AND DESIGN IS EXCLUSIVE PROPERTIES OF CUIL AVAITON AUTHORITY OF THE PHILIPPINES AND SUCH MUST NOT ER REPRODUCED, EXHISTED, LOANED NOR COPIED IN PART OR IN WHOLE WITHOUT PROPER PERMISSION ANDIOR WITTEN CONSENT FROM THE DIRECTOR GENERAL CAAP.

AERODROME DEVELOPMENT AND MANAGEMENT SERVICE

INFRASTRUCTURE DEVELOPMENT AND DESIGN DIVISION

DESIGN STAFF: INITIAL / DATE
DESIGNED BY: IDDD
DRAWM BY: JGMC
CHECKED BY: RUAJR

REVIEWED BY:

RAULR CRUCENA Division Chief III, IDDD-ADMS

SUBMITTED BY:

ARNELF. BORLADO
Department Manager III, AED-ADMS

RECOMMEND APPROVAL

LT COL VALENTINO A DIONELA PAF (RET)

APPROVED:

CAPTAIN MANUEL ANTONIO L. TAMAYO
Director Oppleral

NOTES/REVISION

PROJECT:

IMPROVEMENT/REHABILITATION OF PASSENGER TERMINAL BUILDING OF ITBAYAT AIRPORT

LOCATION

ITBAYAT, BATANES


SHEET CONTENTS:


ARRIVAL AREA VENTILATION LAYOUT

ARRIVAL AREA FDAS & FIRE EXTINGUISHER LAYOUT

AS SHOWN SHEET NO:

M-4

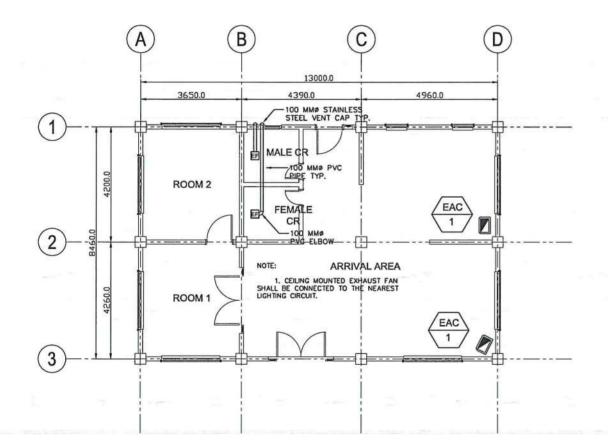

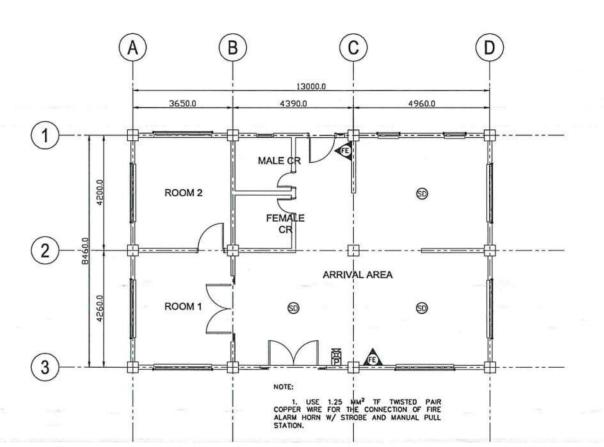

ARRIVAL AREA VENTILATION LAYOUT
M-4 M-4 SCALE: 1:75 M

2 FDAS & FIRE EXTINGUISHER LAYOUT

SCALE: 1:75 M