

Republic of the Philippines CIVIL AVIATION AUTHORITY OF THE PHILIPPINES

BID BULLETIN NO. 4 Bid No. 21-018-09 Charlie

24 September 2021

This Supplemental/Bid Bulletin is issued to modify, amend or clarify items in the Bidding Documents for the BUKIDNON AIRPORT DEVELOPMENT PROJECT - PHASE III (Passenger Terminal Building, Runway Strip, Runway Extension, 2-units Pipe Conduit, Box Culvert and Runway Markings).

- New schedule for the deadline of the submission and opening of Bids will be on 04 October 2021, 2:00 PM at CAAP Conference Room (4th Floor), MIA Road, Ninoy Aquino Avenue, 1300 Pasay City, Metro Manila.
- 2. The following table contains queries from the bidders with corresponding clarifications:

Queries	Clarifications/Amendment
a) Inconsistency in the Bill of Quantities for the scope of work "Supply and Installation of Baggage Handling System" listed as Item 6.0 with the quantity of 22 sets. The same scope of work is listed as item 2.0 with the quantity of 1.00 lot in the Bill of Materials and Cost Estimate.	The correct Item No. and Quantity/Unit for the "Supply and Installation of Baggage Handling System" work is 6.0 and 1 lot, respectively. This shall be reflected on the Financial Component forms such as Bill of Quantities (CAAP-BAC-SF Annex "C" Form 1) (page 249), Summary of Bid Proposal (CAAP-BAC-SF Annex "C" Form 2) (page 253), and Bill of Materials & Cost Estimate (CAAP-BAC-SF Annex "C" Form 3) (page 296). See attached corrected forms.
b) We'd want to know if the CCTV units will be IP or Analog, and if, according to the BOQ, the video recorder will be a DVR while we have network switching requirements? For your clarification.	For Item 3.12 CCTV, Voice and Data System under Electrical Works, the IP CCTV cameras will be used and for the DVR, as per BOQ, is a device that supports analog AHD/IP/TVI/CVBS/CVI Cameras.
c) Please provide Fire Protection Plans & Details	The requirement is Portable Fire Extinguishers with wall hangers only. Please refer to attached additional plans, Sheet Nos. FE-1 and FE-2.
d) Please clarify conflict in drawing 2S-4 detail 3 (see below figure). The detail shows 5 sets of Ties only. However, the statement below indicates 6 sets.	It should be written as: "Ties: 5-10Ø; 1@50; Rest@100"
BASEPLATE AND COLUMN DETAIL (C-1) S 4 SCALE 1:10 M	

	e)	Can you pls provide one-line diagram	See attached One-line Diagram.	
		of the ff;		
		CCTV System		
		Voice & Data System		
-		FDAS		
		PA System		
J				ı

- 3. Correction on the issued Bid Bulletin No. 2 for *Item 2.06 Curtain Glass Wall Panel* of Architectural Work under Construction of PTB, attached in this bid bulletin is the revised Bill of Materials & Cost Estimate (CAAP-BAC-SF Annex "C" Form 3) (page 270) for said item.
- 4. Correction on the issued Bid Bulletin No. 2 for *Item 3.00 Electrical Works* under Construction of PTB, the feeder conductor from PTB to Power Maintenance Building is included in the scope of work. (See plans for length and layout.) While termination and layout within the Power Maintenance Building is not included.

This Bid Bulletin should be included in the Technical Requirements and be marked accordingly. This serves as an integral part of the bidding documents of the project and non-inclusion of this Bid Bulletin in the Technical Requirements will constitute disqualification.

For the information and guidance of all concerned.

CAPTAIN DONALDO A. MENDOZA Chairman, Bids and Awards Committee

CAAP-BAC-SF Annex "C" Form 1

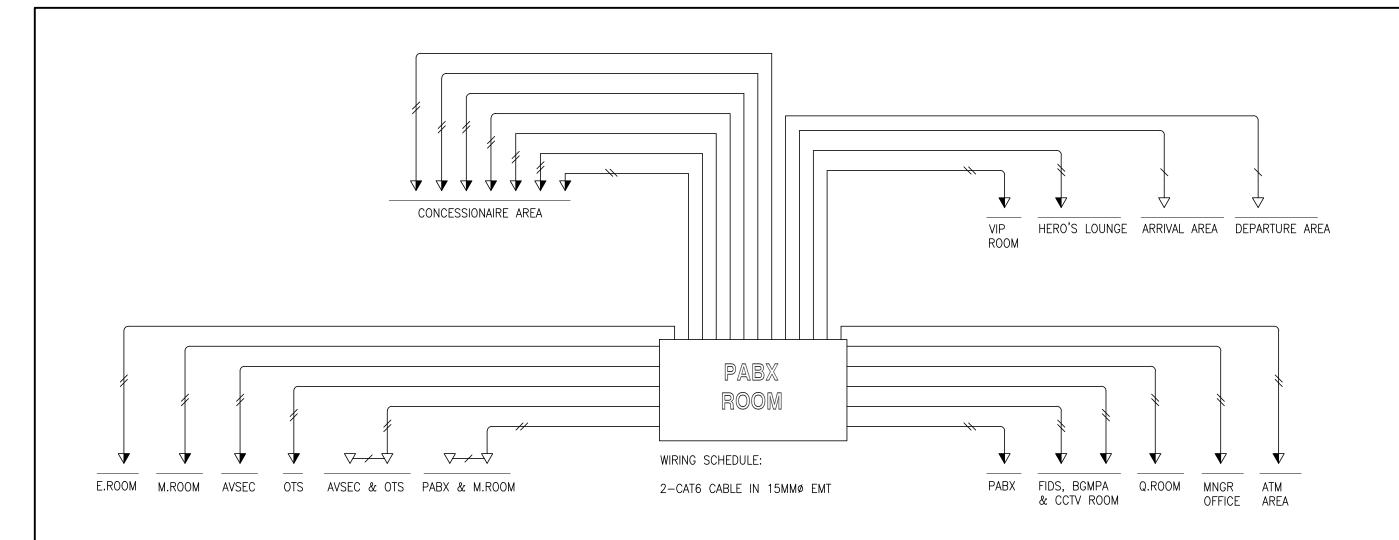
5.05	Septic Tank & Catch Basin	32.92	cu.m.	
	Pesos Amount in Words			
	and			
	centavos			
5.06	Fixtures & Accessories	1.00	lot	
	Pesos Amount in Words			
	and		,	
	centavos			
	CURRILY S. INSTALLATION OF BACCACE HANDLING			
6.00	SUPPLY & INSTALLATION OF BAGGAGE HANDLING SYSTEM	1.00	lot	
	Pesos Amount in Words			
	and			
	centavos			
В	RUNWAY STRIP			
100	Clearing & Grubbing	258,808.00	sq.m.	
	Pesos Amount in Words			
	and			
	centavos			
102	Excavation & Disposal	520,341.00	cu.m	
	Pesos Amount in Words			
	and			
	centavos			
104	Embankment	924,414.85	cu.m	
	Pesos Amount in Words			
	and			
	centavos			

									 		1
3.08	Grounding System	528.00	1.m.						 		
3.09	Feeder Conductors	3,988.00	I.m.						 		
3.1	Feeder Conduits and Fittings	348.00	1.m.						 		
3.11	Termination Accessories	60.00	pcs						 		
3.12	CCTV, Voice and Data System	1.00	lot						 		
3.13	Fire Detection and Alarm System	1.00	lot								
3.14	Public Address System	1.00	lot								
4.00	MECHANICAL WORKS										
4.01	Air-Conditioning Works	937.20	sq. m.							***************************************	
4.02	Ventilation Works	199.19	sq. m.								
5.00	PLUMBING WORKS										
5.01	Site Works	277.00	cu.m								
5.02	Sewer Line System	609.11	li.m.								
5.03	Water Line System	314.64	li.m.								
5.04	Storm Drainage System	201.20	li.m.						 		
5.05	Septic Tank & Catch Basin	32.92	cu.m.								
5.06	Fixtures & Accessories	1.00	lot								
6.00	SUPPLY & INSTALLATION OF BAGGAGE HANDLING	1.00	lot						ALL VALUE OF THE PARTY OF THE P		
0.00	SYSTEM								 		
В	RUNWAY STRIP	258,808.00					-		 		
100	Clearing & Grubbing	520,341.00	sq.m.						 		
102	Excavation & Disposal	924,414.85							 		
104	Embankment	924,414.85	cu.m						 		
С	RUNWAY EXTENSION			***************************************							
200	Aggregate Subbase Course	3,377.40	cu.m.					18.00			
206	Cement Treated Base Course	1,755.00	cu.m.								
311	Portland Cement Concrete Pavement (PCCP)	11,700.00	sq.m.								
D	2-UNITS PIPE CONDUITS										
102	Excavation & Disposal	136.00	cu.m.								
1.00	Concreting Works	51.00	cu.m.								
E.	BOX CULVERT								 		
1.00	Drainage Excavation	32,104.00	cu.m.						 		
2.00	Backfill including Gravel Base	7,722.94	cu.m.						 		
3.00	Concrete Works	6,312.43	cu.m.						 		
F	RUNWAY MARKINGS	4,704.00	sq.m.						 		
SPL 4	SUPPLY OF GANG CHAIRS	1.00	lot						 		
	TOTAL AMOUNT										

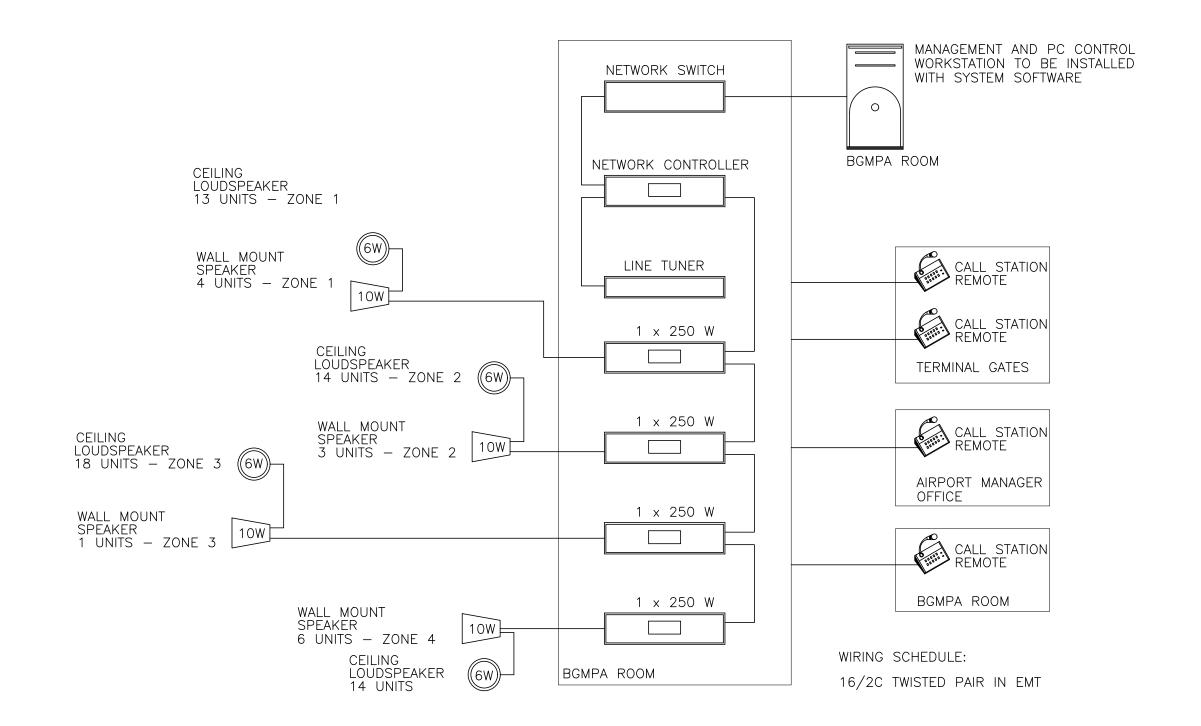
Submitted by:

NAME OF PROJECT : BUKIDNON AIRPORT DEVELOPMENT PROJECT PHASE III DESCRIPTION : CONSTRUCTION OF PASSENGER TERMINAL BUILDING								
LOCAT		DOLLDING	- 1	QTY.	UNIT			
SUBJEC	T : BILL OF MATERIALS & COST ESTIMATE			1.00	lot			
6.00	DESCRIPTION SUPPLY AND INSTALLATION OF BAGGAGE HANDLING SYSTEM	QUANTITY	UNIT	UNIT PRICE	AMOUNT (P)			
A	Materials Weighing Conveyor complete with cladding, frames, Electronic Weigh Scale corof 500 kg load cells, remote LCD indicator, leveling foot pad, foot pedal swit control panel, circuit breakers, wirings and other standard accessories Dimension: 600 mm belt width x 1,200 mm length x 400 mm height (Top of Belt: 600 mm belt width, 3.1 ± 0.2 mm thick, 2-ply Cladding: 3 mm. thick, Hairline finished Drive: 220-240 V, 60 Hz, 3 Ph, 0.37 KW foot mounted motor positioned insi	ch, f belt)	sets					
	the conveyor frame							
	Index Conveyor complete with cladding, frames, electrical controls, levelling fo turn pole roller and other standard accessories Dimension: 600 mm belt width x 1,200 mm length x 400-450 mm height (T Drive: 220-240 V, 60 Hz, 3 Ph, 0.37 KW foot mounted motor positioned insi the conveyor frame	op of belt)	sets					
	Collection Conveyor complete with cladding, frames, electrical controls, VFD, emergency stop button, levelling foot pad and other standard accessories Dimension: 1,000 mm belt width x 20,000 mm length x 400 mm height Drive: 220-240 V, 60 Hz, 3 Ph, 2.2 KW shaft mounted motor Speed: 25 m./min.	1.00	set					
	Transport Conveyor No. 1 complete with cladding, frames, electrical controls, emergency stop button, levelling foot pad and other standard accessories Dimension: 1,000 mm belt width x 8,500 mm length x 400 mm height Drive: 220-240 V, 60 Hz, 3 Ph, 1.5 KW shaft mounted motor Speed: 25 m./min.	VFD, 1.00	set					
	Transport Conveyor No. 2 complete with cladding, frames, electrical controls, emergency stop button, levelling foot pad and other standard accessories Dimension: 1,000 mm belt width x 13,000 mm length X 400 mm height Drive: 220-240 V, 60 Hz, 3 Ph, 1.5 KW shaft mounted motor Speed: 25 m./min.	VFD, 1.00	set					
	Out of Gauge Weighing Scale complete with 500 kg load cells, remote LCD ind cladding, frame, pedestal and other standard accessories Dimension: 1,200 mm length x 1,000 mm width x 130 mm height Capacity: 150 kg. with overload capacity up to 750 kg.	icator, 1.00	set					
	Gravity Roller Conveyor complete with frames, levelling foot pad and other sta accessories Dimension: 1,000 mm width x 6,000 mm length x 400 mm height Rollers: Zinc coated, 50 mm dia., 75 mm pitch center to center, 25 mm gap		set					
	Baggage Claim Carousel, "T" Shape, Flat Type complete with cladding, frames, panel, VFD, circuit breaker, overload relays, contactors, switches, wirings, er stop buttons, tower light w/ buzzer alarm, leveling foot pad and other stands Dimension: 46 m. Equivalent Straight Length x 1,012 mm Width x 400 mm Drive: 220-240 V, 60 Hz, 3 Ph, 2 x 2.2 KW motor Slat: 1,000 mm W x 5 mm T Overlapping rubber slat Cladding: Stainless Steel 304, 3 mm. thick, Hairline finished (Passenger Side Mild Steel, 3 mm. thick, Primed and Painted (Air Side) Center in-fill: Enclosed and finished by fine rated/marine plywood Support by metal framework and covered with carpeting	nergency ard accessories Height	set					
	Roll-up Shutter door, Aluminum type with Automatic and Manual Functions co with standard accessories	mplete 3.00	sets					
	Draft Curtain, 1,200 mm x 1,200 mm, overlapping, complete with standard ac	cessories 3.00	sets					
	 Shipping, Delivery and Transportation	1.00	lot					
	Welding Rod 1/8", 5 kg/box		boxes					
В	Labor Construction Foreman Skilled Laborer Common Laborer	QTY	Our (Day)	RATE/DAY				
			Labor Cost					
С	Equipment Portable Generator Set (10 KVA) Portable Welding Machine (10-200 Amp)	QTY	DUR. (Day)	RATE/DAY				
		Equ	ipment Cost					
A	TOTAL MATERIAL COST		L					
В	TOTAL LABOR COST							
C	TOTAL EQUIPMENT COST TOTAL DIRECT COST							
	INDIRECT C	OSTS						
	1 (0% - 8% of TDC) ITRACTOR's PROFIT (0% - 8% of TDC)							
E. TOT	AL OCM & PROFIT							
	UE ADDED TAX, (VAT) 5.0% TAL ESTIMATED INDIRECT COST (E + F), P	of (D + E)						
н. тот	AL ESTIMATED UNIT INDIRECT COST (G / Quantity), P/Unit							
	TOTAL ESTIMATED COST (D + G), P TOTAL ESTIMATED UNIT COST (Total Estimated Cost / Quantity), P/Unit							

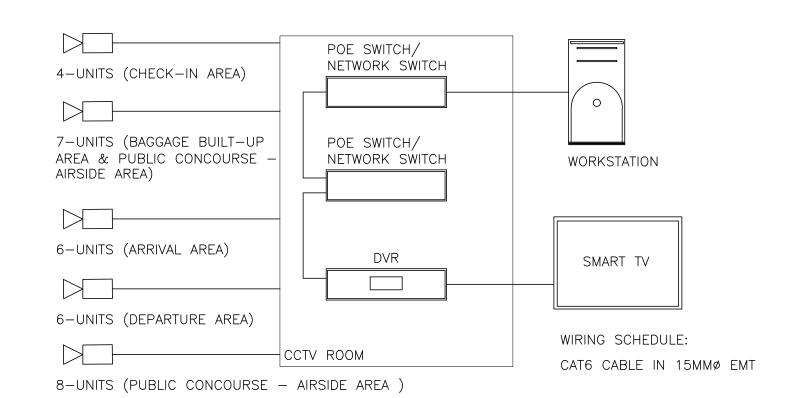
		QUANTITY	UNIT					
2.00	ARCHITECTURAL WORK				815.00	sq.m.		
ITEM	DESCRIPTION		QUANTITY	UNIT	UNIT COST	AMOUNT		
	Curtain Glass Wall Panel							
	Materials Curtain Wall Glass Panels, (Double Glazing , 2-12mm thk)			sq.m. Material Cost				
В	Labor (including tools & equipment cost)		QTY	DUR. (DAYS)	RATE/DAY			
	Construction Foreman Skilled Laborer Common Laborer				,			
				Labor Cost		e		
	A Curtain Glass Wall Panel Works Total Material (Cost						
	B Curtain Glass Wall Panel Works Total Labor Cos	it						
	D Curtain Glass Wall Panel Works Total Direct Co	st						
	IN	DIRECT	COSTS					
	M (0% - 8% of TDC) NTRACTOR's PROFIT (0% - 8% of TDC)							
E. TO	TAL OCM & PROFIT							
F. VAI	LUE ADDED TAX, (VAT) 5.1	0%	of (D + E)					
	G. TOTAL ESTIMATED INDIRECT COST (F + E), P							
	H. TOTAL ESTIMATED UNIT INDIRECT COST (G / Quantity), P/Unit							
TOTA	TOTAL ESTIMATED COST (D + G), P							
TOTA	L ESTIMATED UNIT COST (Total Estimated Cost / Qua	antity), P/U	nit					



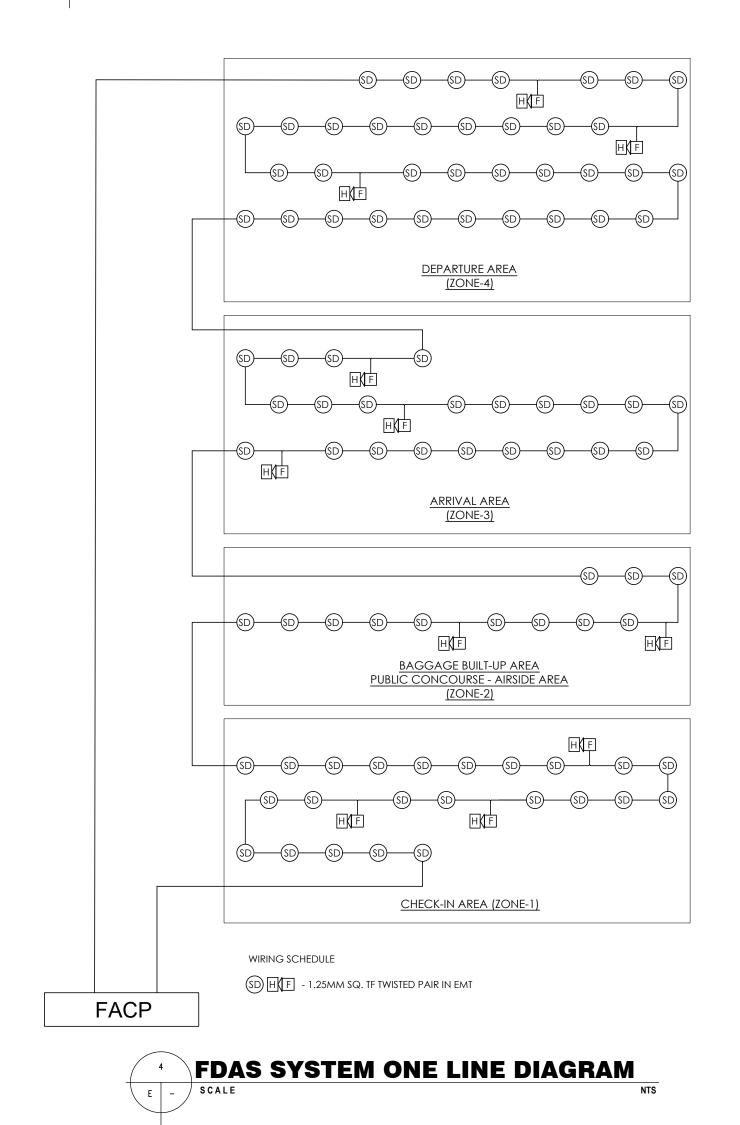














REPUBLIC OF THE PHILIPPINES

CIVIL AVIATION AUTHORITY OF THE PHILIPPINES AERODROME DEVELOPMENT AND MANAGEMENT SERVICE NAIA ROAD, 1300 PASAY CITY

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AERODROME DEVELOPMENT AND MANAGEMENT SERVICE

INFRASTRUCTURE DEVELOPMENT AND DESIGN DIVISION

DESIGN STAFF:	INITIAL / DATE	
DESIGNED BY:		
DRAWN BY:	JPCJR	
CHECKED BY:	RUAJR	

REVIEWED BY:

EMERSON P. SALAS
Senior Aerodrome Engineer, IDDD - ADMS

SUBMITTED BY:

ARNEL F. BORLADO

Department Manager III, AED-ADMS

RECOMMEND APPROVAL:

LT COL VALENTINO A DIONELA PAF (RET)
Assistant Director General II, ADMS

APPROVED:

CAPTAIN JIM C. SYDIONGCO

Director General

CONCURRED:

JAIME ALBERTO C. MELO
Assistant Secretary for Aviation and Airports, DOTr

NOTES/REVISIONS:

PROJECT:

BUKIDNON AIRPORT DEVELOPMENT PROJECT (CONSTRUCTION OF PASSENGER TERMINAL BUILDING)

LOCATION:

BUKIDNON AIRPORT BRGY. MARAY MARAY, DON CARLOS, BUKIDNON

SHEET CONTENTS:

• DNE LINE DIAGRAM

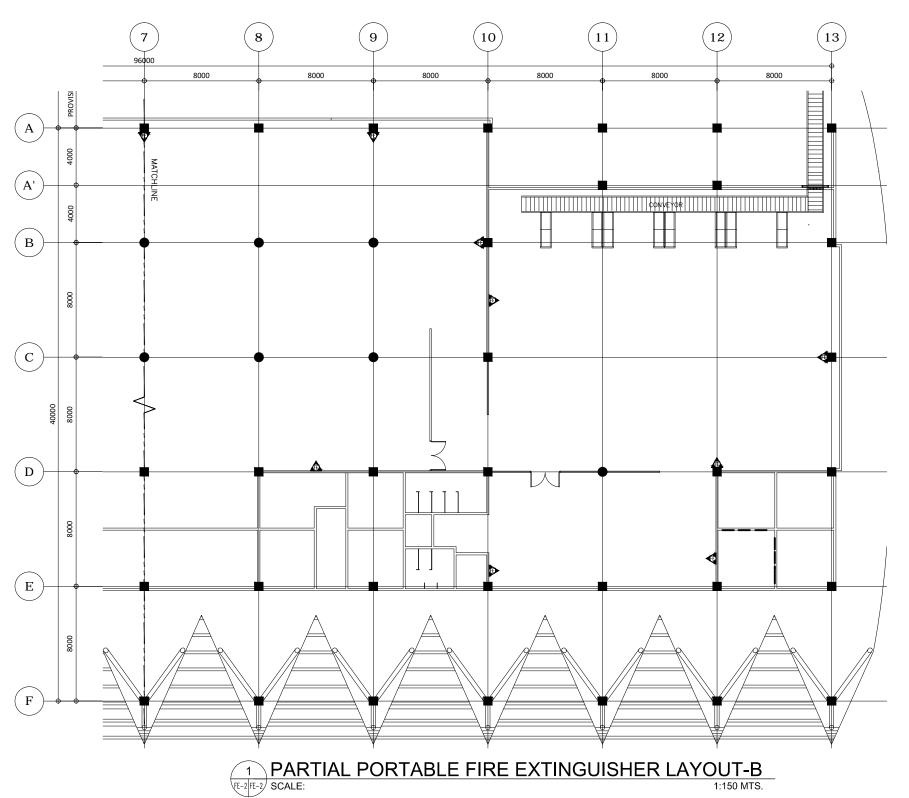
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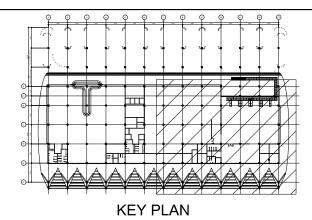
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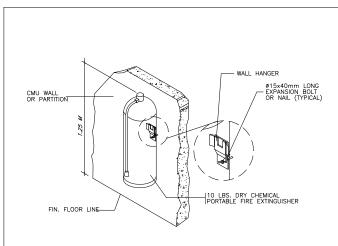
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10 LBS. DRY CHEMICAL PORTABLE FIRE EXTINGUISHER W/ WALL HANGER







PORTABLE FIRE EXTINGUISHER DETAIL



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AERODROME DEVELOPMENT AND MANAGEMENT SERVICE

INFRASTRUCTURE DEVELOPMENT AND DESIGN DIVISION

DESIGN STAFF:	INITIAL / DATE					
DESIGNED BY:						
DRAWN BY:	JCMC					
CHECKED BY:	RUAJR					

REVIEWED BY:

EMERSON P. SALAS Senior Aerodrome Engineer, IDDD - ADMS

SUBMITTED BY:

ARNEL F. BORLADO Department Manager III, AED-ADMS

RECOMMEND APPROVAL:

LT COL VALENTINO A DIONELA PAF (RET)

APPROVED:

CAPTAIN JIM C. SYDIONGCO

CONCURRED:

JAIME ALBERTO C. MELO

NOTES/REVISIONS:

PROJECT:

BUKIDNON AIRPORT DEVELOPMENT PROJECT (CONSTRUCTION OF PASSENGER TERMINAL BUILDING)

LOCATION:

BUKIDNON AIRPORT BRGY. MARAY-MARAY, DON CARLOS, BUKIDNON

SHEET CONTENTS:

PARTIAL PORTABLE FIRE EXTINGUISHER LAYOUT-B

KEY PLAN

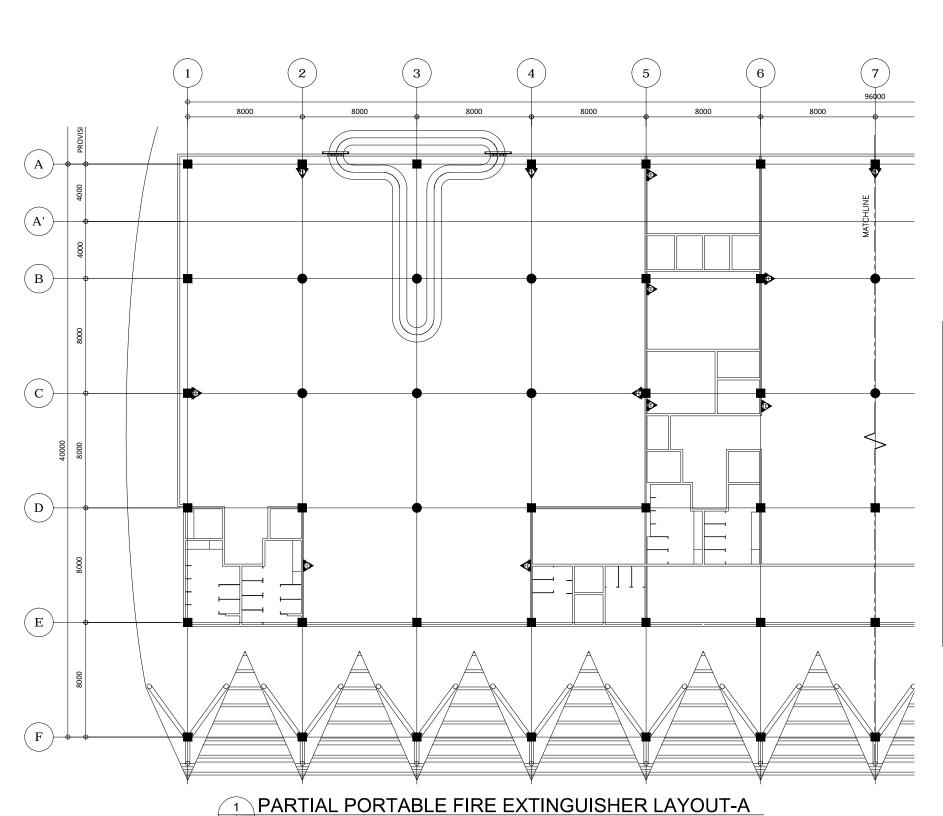
PORTABLE FIRE EXTINGUISHER DETAIL

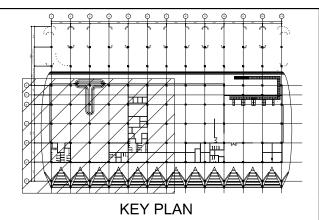
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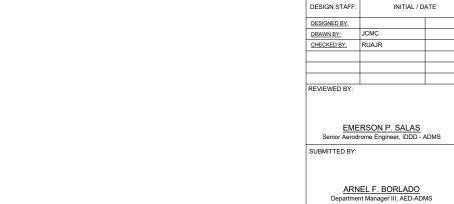
LEGEND:

10 LBS

10 LBS. DRY CHEMICAL PORTABLE FIRE EXTINGUISHER W/ WALL HANGER







LT COL VALENTINO A DIONELA PAF (RET)
Assistant Director General II, ADMS
APPROVED:

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AERODROME DEVELOPMENT AND

MANAGEMENT SERVICE

INFRASTRUCTURE DEVELOPMENT AND DESIGN DIVISION

CAPTAIN JIM C. SYDIONGCO
Director General

CONCURRED:

JAIME ALBERTO C. MELO
ssistant Secretary for Aviation and Airports, DOT

NOTES/REVISIONS:

....

BUKIDNON AIRPORT DEVELOPMENT PROJECT (CONSTRUCTION OF PASSENGER TERMINAL BUILDING)

LOCATION:

BUKIDNON AIRPORT BRGY. MARAY-MARAY, DON CARLOS, BUKIDNON

SHEET CONTENTS:

PARTIAL PORTABLE FIRE EXTINGUISHER LAYOUT—A

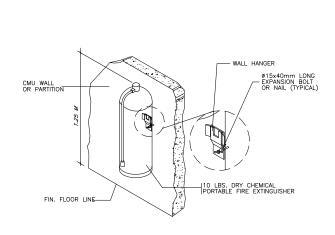
KEY PLAN

PORTABLE FIRE EXTINGUISHER DETAIL

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PORTABLE FIRE EXTINGUISHER DETAIL